SITE PLAN APPLICATION

	SILLILI		
	1	Γ	☐ Site Plan Amendment
🔼 Site Plan			
_	nufacturing Facility at 76 Fu	ller Way, Berlin, CT	
Project Name: Ma	nutacturing Facility at 70 a		
Project Name:IVIAI Property Owner(s): _ Project Address*: Map:10Blo	The big A LEC	0.0027	
	76 Fuller Way, Bernii, CT	- () CI	Lot Area: 2.6 acres
	ock: 1 Lot: 83-20B	Zone(s): GI	
	ect all relevant items below:		
Please sele	ect all relevant items below. al Permit – Also complete specia	l permit application form	
□ Proper	rty is within 500 feet of a friding	-r	
☐ Hope	rty is within 500 feet of a Munic doment to Zoning Regulations – adment to Zoning Map – Zone(s)	Section(s)	
	dment to Zoning Map - Longs		
□ Zonir	ng Board of Appeals review need	led	
☐ Inlan	ng Board of Appeals review flood d Wetlands and Water Course C	OHIIIISSIOII IOVIOVI III	
		nt Information	isey, Pearson & Cassidy Enginee
		Associat	tes, Inc.
Name II N Cot	ntracting	Firm Name: Associat	GT. CT 7in: 06416
Name: JETT Co.	630 Main Street	Cromwell	S1: C1 Znp
Street Address:	@hpcengr.com	Phone: (860) 529-6	812
Email: Cassing	(enfects)		
Signature:			
•		formation (If Not the App	plicant)
	Property Owner(s) In	MI mativa (D'Margo
mi T	Dia A II C	Principal: Stephen A	A. DiMarco
Name: The I	DIG A LLC	CITY: DCITIT	
Street Address:	/6 runer Road	Phone:	
Email:			
*Letter of Autl	norization Required		

^{*}Any town official and/or employee that the town deems necessary may enter the property to verify information submitted with this application.

This project will consist of a change of the or the change of the change
Description of Project .
a limousine service to a manufacturing / recycling use for a company The majority of the existing building will be remain. Approximately 4,800 sq. ft. of the roof
The majority of the existing building will be remain. Approximately
on the existing building will be raised to accommodate equipment for the new use.
I desire a desire of the building, and many
A truck scale and finished product our ways are improvements will be made to improve truck circulation. *If more space is needed, then please provide separate narrative document.

SITE PLAN ZONING STATISTICS

EXISTING manufacturing	PROPOSED manufacturing & re	REQUIRED ecycling
24,862 s. f.	24,862 s. f.	
	manufacturing 24,862 s. f.	manufacturing manufacturing & reconstruction manufacturing manufac

To be completed by P&Z staff only:				
Fee Paid \$ 260	(Refer to current Fee Schedule)			
Received by: MX	CINK#11648			
- 0	•			

APPLICATION: Sile Flan Amendment

JLN Contracting **APPLICANT:**

c/o Hallisey, Pearson & Cassidy Engineering Associates, Inc.

LOCATION:

76 Fuller Way

July 15, 2021 AGENDA DATE:

To the Applicant:

These are the comments received to date, additional comments may be forthcoming.

• Please submit any written response to Maureen Giusti, Acting Town Planner/Zoning Enforcement Officer at <u>mgiusti@town.berlin.ct.us</u> or revised plans directly to the Planning & Zoning Department in Room 121. We will forward your comments or distribute materials to the relevant departments.

Health District

No comment

Economic Development

No comment

Board of Police Commissioners

No comment

Police Chief

No comment

Inland Wetlands

Install "Abtech Ultra Urban Filter with Smart Sponge Technology" or equal in all catch basins.

Building Official

• Complete stamped drawings including M.E.P.'s with permit application required.

Fire Marshal

No comment

Emailed to Applicant: July 7, 2021

Chairwoman
Planning and Zoning Commission
Town of Berlin
240 Kensington Road
Berlin, CT 06037

Re: JLN Contracting c/o Smart Feed Tech

Dear Chairwoman Veley and Commission Members:

The Planning Department as well as I have been working closely with the applicant, JLN Contruction, as well as Hallisey, Pearson & Cassidy for some time on this project. The building that is under consideration this evening is the former location of Premier Limousine. Thankfully, the building will have a new life with the application before you.

Smart Food Tech will be bringing new technology and an exciting project to town at 76 Fuller Way. Their work will be recycling food "waste" which would normally end up in landfills and instead turn it into usable feed for animals.

This is a wonderful project which will again bring investment and jobs to Berlin. Much like Murphy Road, I am thrilled that the Town of Berlin and this new firm will be on the cutting edge of technology in this field.

Thank you very much for your time and consideration of this.

Sincerely,

Christopher Edge

CI 2 C

Economic Development Director

Visit our Web Site http://www.town.berlin.ct.us

SITE PLAN MODIFICATION

FOR

SMART FEED TECH

PROPERTY LOCATED AT: #76 FULLER WAY BERLIN, CONNECTICUT

OWNER

THE BIG A, LLC 76 FULLER WAY BERLIN, CT 06037


APPLICANT & DEVELOPER

JLN CONTRACTING, ON BEHALF OF SMART FEED TECH C/O HALLISEY, PEARSON & CASSIDY ENGINEERING ASSOC., INC 630 MAIN STREET CROMWELL, CT 06416

> Town of Berlin Received

> > JUN 14 2021

Planning & Zoning Department Berlin, Connecticut

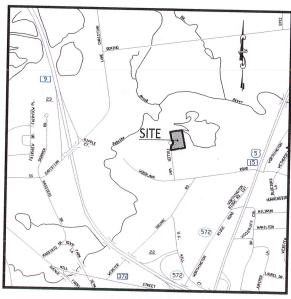



LOCATION MAP

COVIL ENGINEERS & LAND SURVEYORS
630 MAIN STREET, UNIT #1A
CROMMELL, CONNECTICUT 08416
PHONE: (860)-529-6812, FAX: (860)-721-7709

SHEET INDEX

SHEET #	DRAWING TITLE
1	BOUNDARY & TOPOGRAPHIC SURVEY BY WHITESTONE ASSOCIAT
2	SITE DEMOLITION PLAN
3	ZONING IMPROVEMENT LOCATION SURVEY-PROPOSED & SITE LAYOUT PLAN
4	SITE GRADING AND DRAINAGE PLAN
5	EROSION AND SEDIMENT CONTROL PLAN
6-7	SITE DETAILS
A-3	PROPOSED FLOOR PLAN
A-4	PROPOSED ELEVATIONS

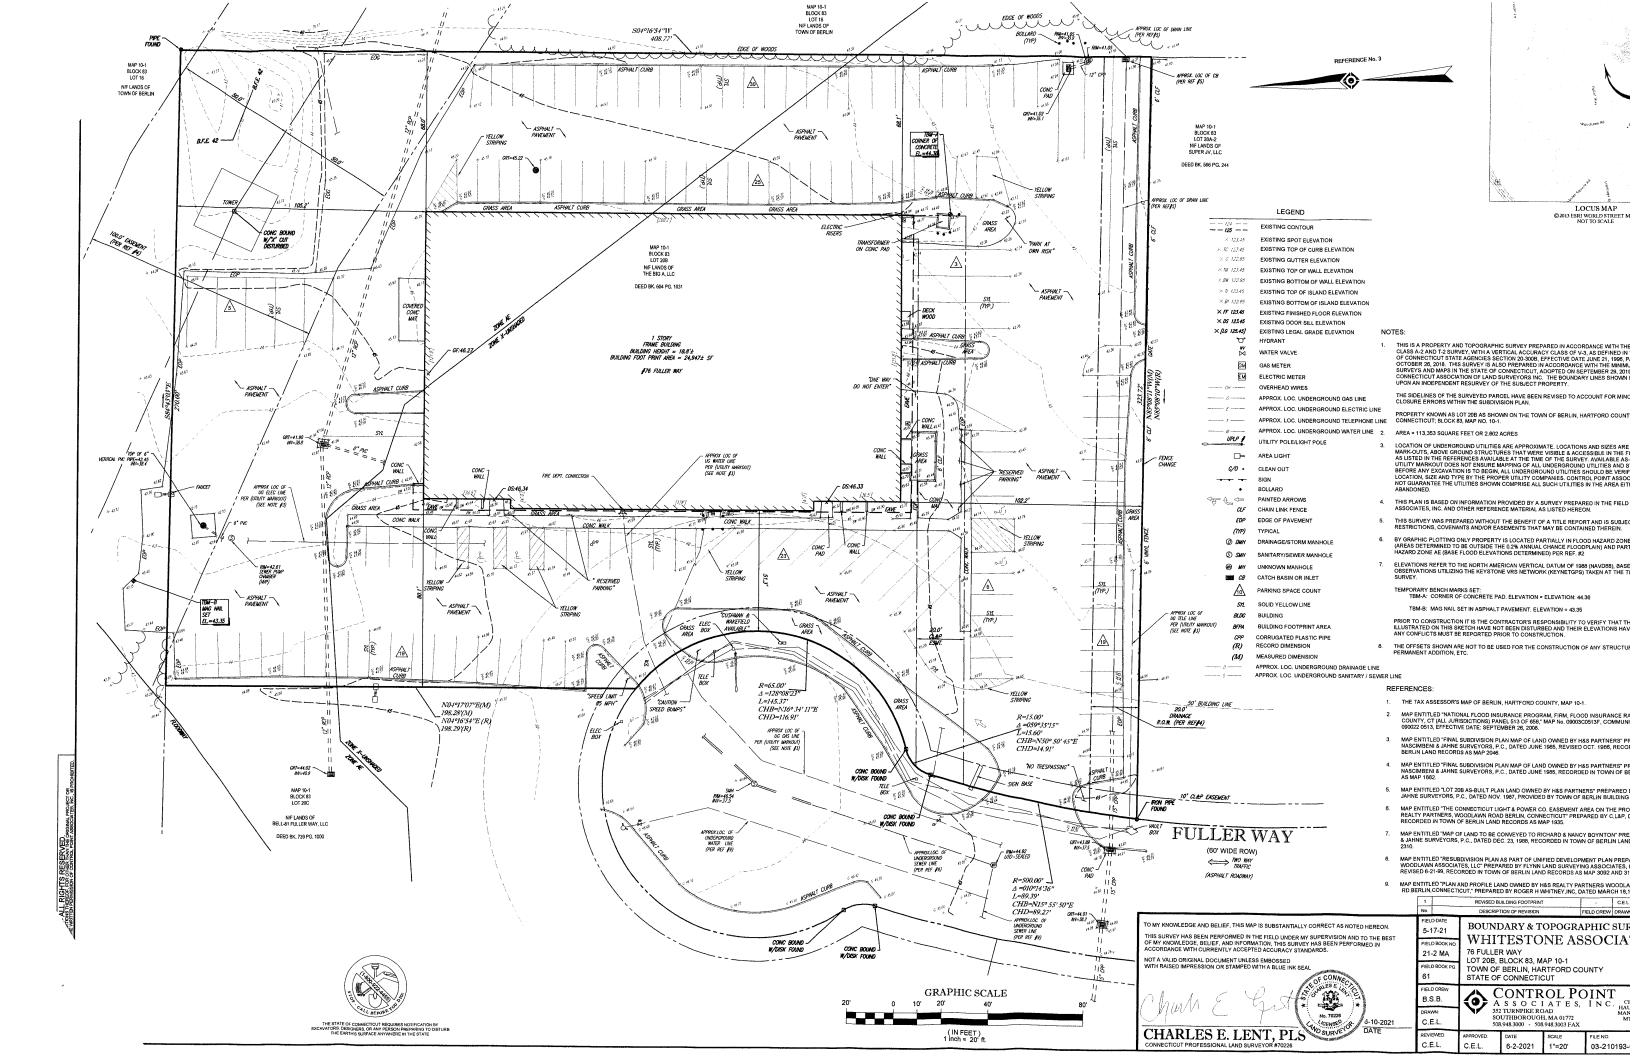

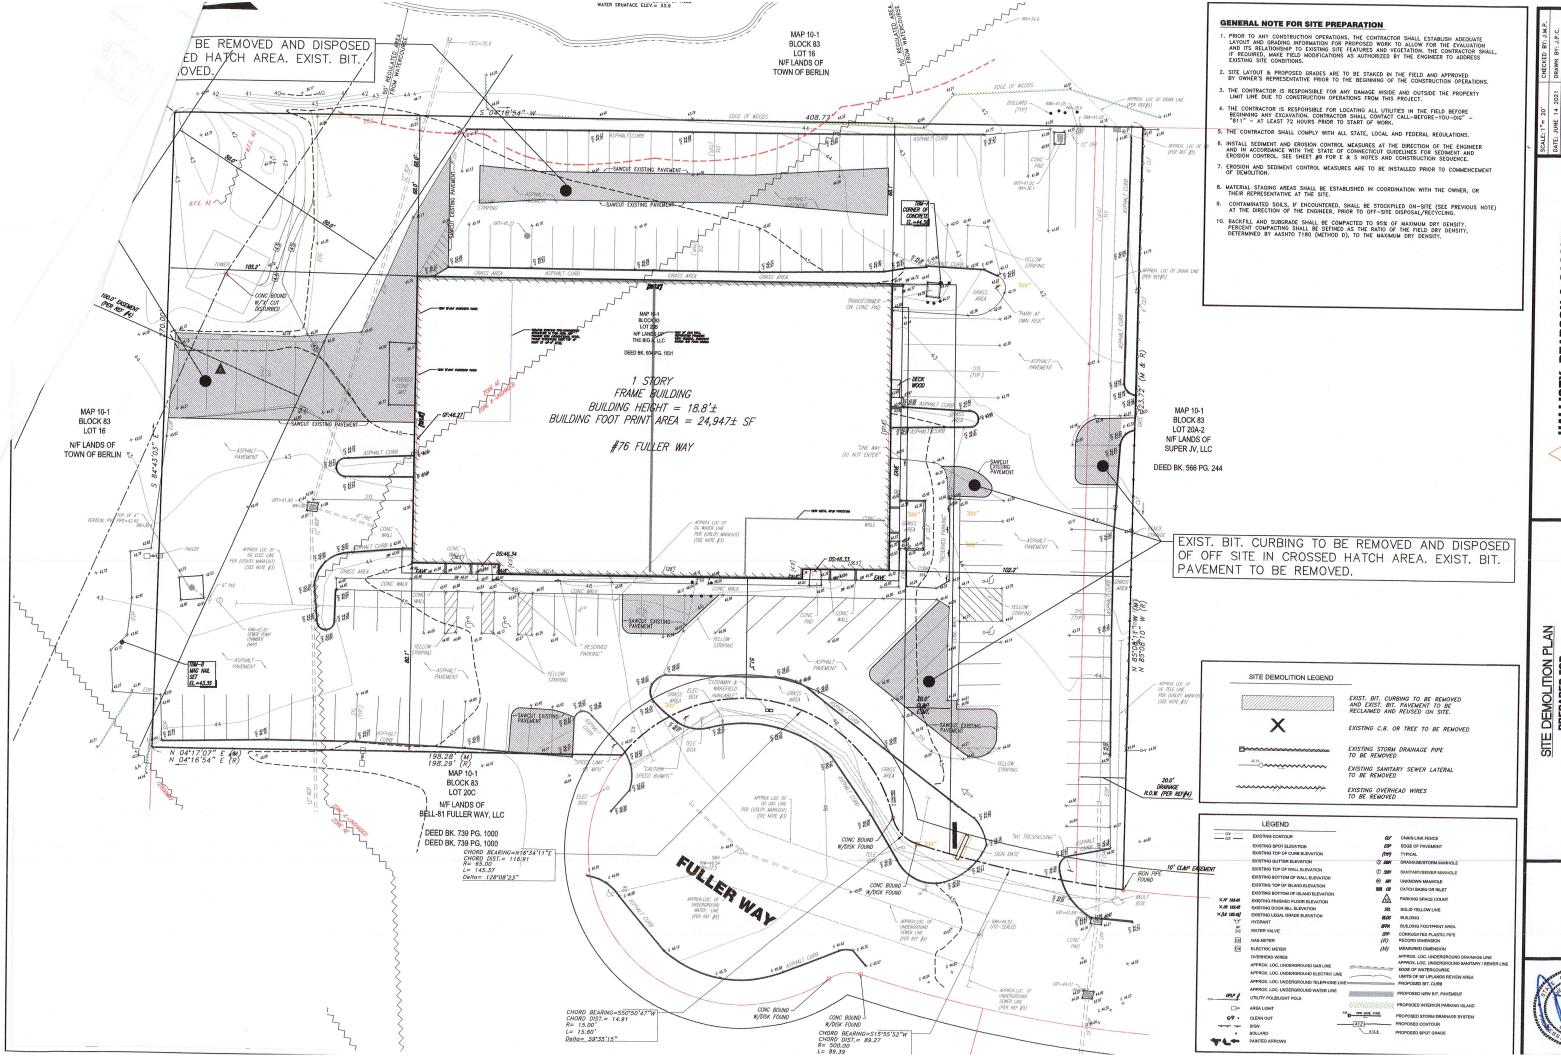


LE: 1"= 20" CHECKED BY: J.M.P.
E: JUNE 14 2021 DRAWN BY: J.P.C.
No: 3243 ACAO FILE: 3243-DE1
ETT: 2 OF: 7


PEARSON & CASSIDY
NEERS & LAND SURVEYORS
MAIN STREET, UNIT #1A

HALLISEY
CIVIL ENG

SITE DEMOLITION PLAN
PREPARED FOR
SMART FEED TECH
PROPERTIES LOCATED AT
#76 FULLER WAY

OF CONNECTION OF

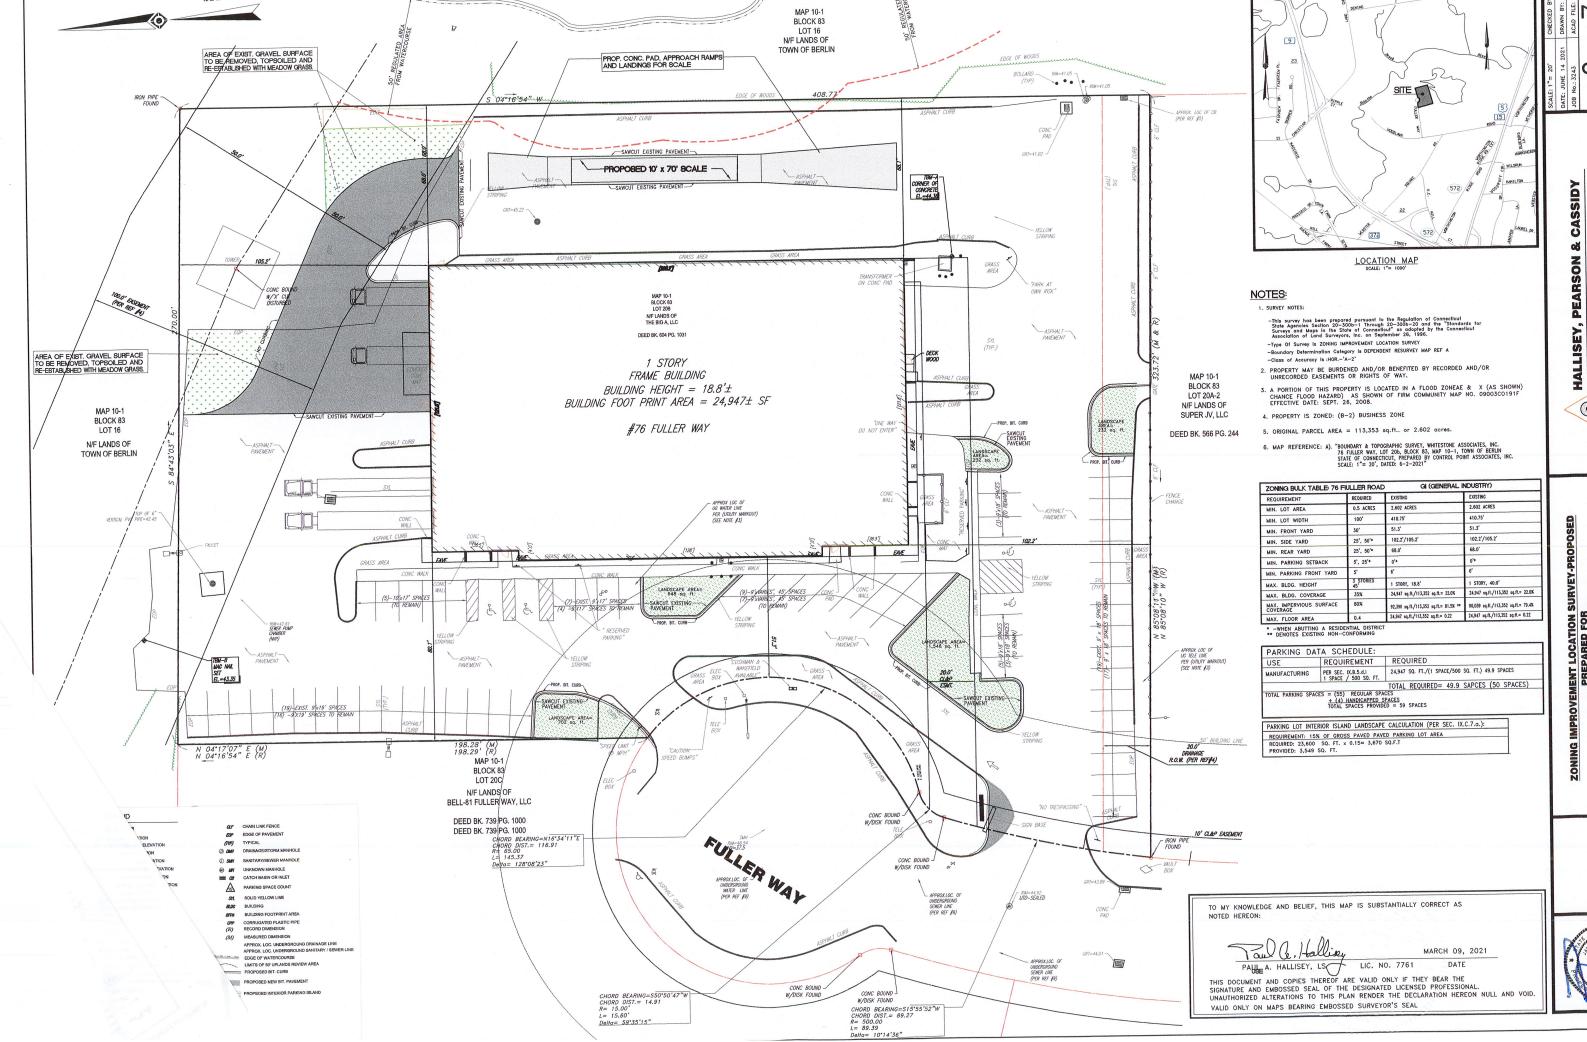

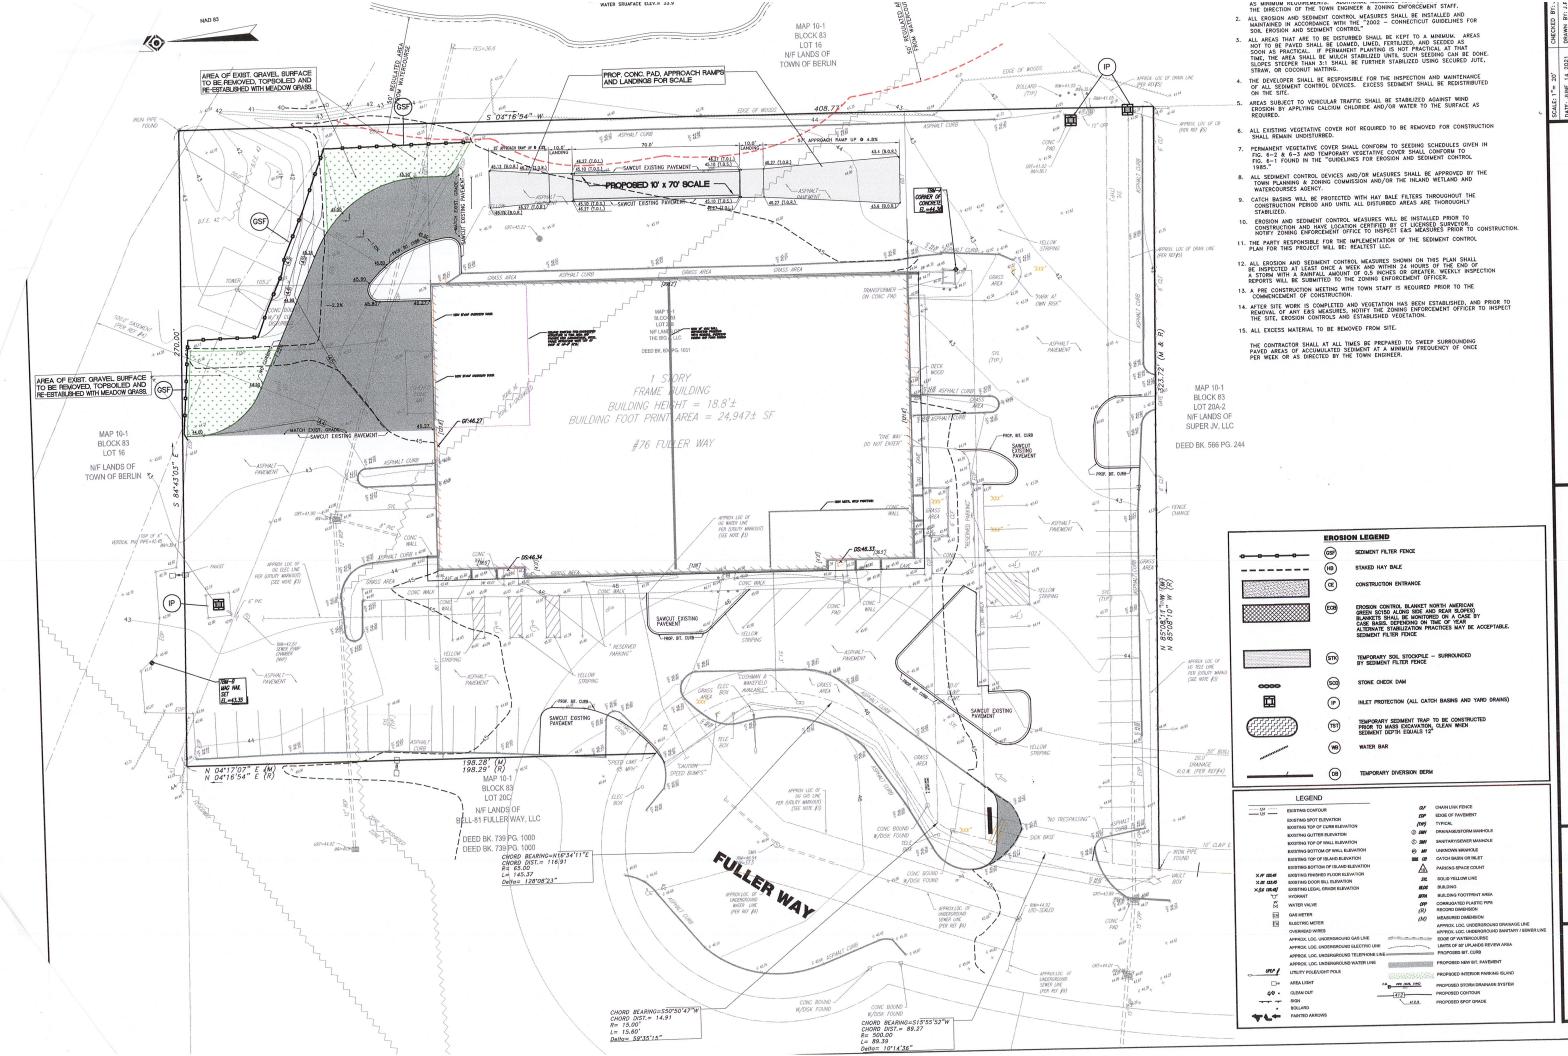


243 ACAD FILE:

JOB No.: 3243

HALLISEY, PEARSON & CASSIDY

EROSION & SEDIMENT CONTROL PLAN

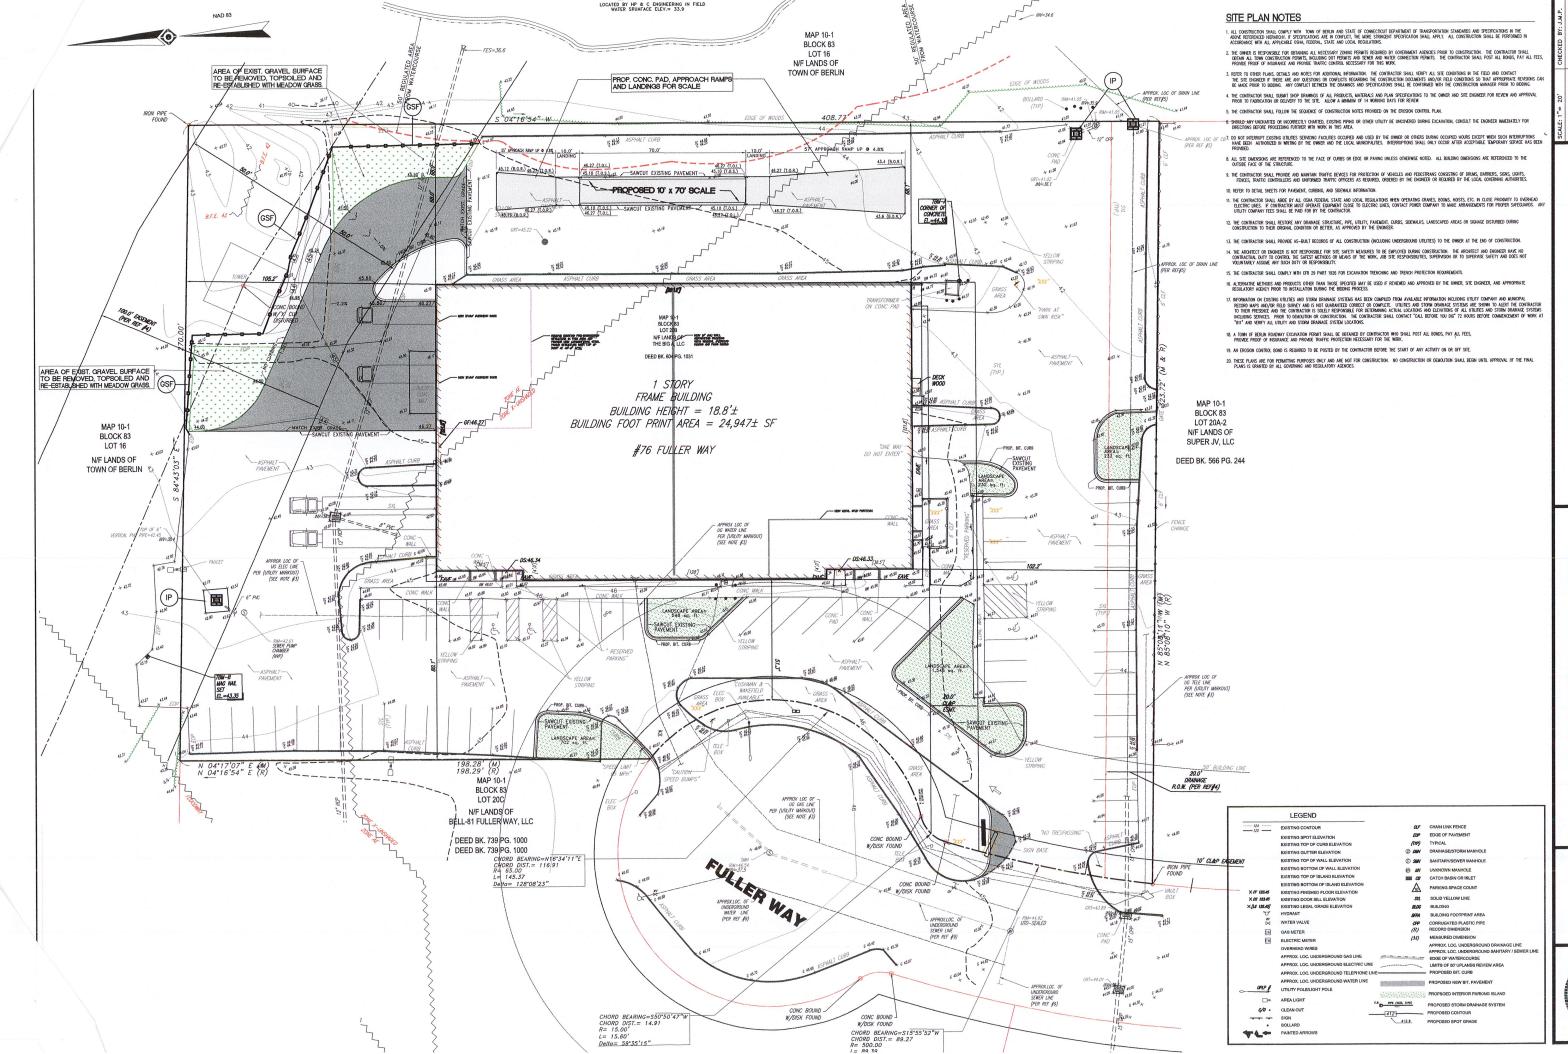

CHECKED BY: J.M.I.
DRAWN BY: J.P.C.
ACAD FILE: 3243-


= 20' CHI E 14 2021 DRJ 243 AC


SCALE: 1"= 20'
DATE: JUNE 14 2
JOB No.: 3243

HALLISEY, PEARSON & CASSIDY


HALLI

MENT LOCATION SURVEY
PREPARED FOR

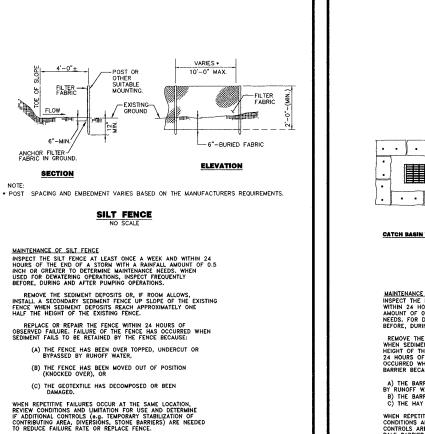

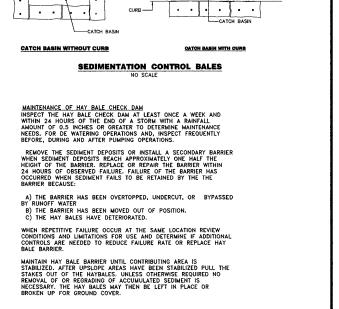

--- BALES TO BUTT TOGETHER

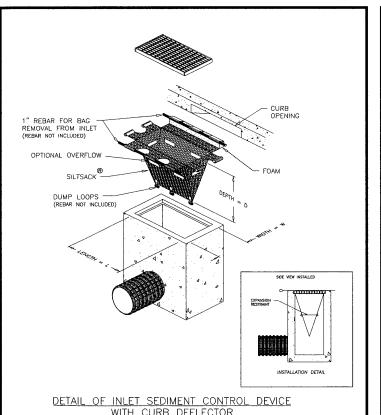


 $\ensuremath{\mathsf{MAINTAIN}}$ THE FENCE UNTIL THE CONTRIBUTING AREA IS STABILIZED.

AFTER THE CONTRIBUTING AREA IS STABILIZED DETERMINE IF SEDIMENT CONTAINED BY THE SILT FENCE REQUIRES REMOVAL OR REGRADING AND STABILIZATION. IF THE DEPTH IS GREATER THAN OR EQUAL TO 6 INCHES, REGRADING OR REMOVAL OF THE ACCUMULATED SEDIMENT IS REQUIRED. NO REMOVAL OR REGRADING IS REQUIRED IF SEDIMENT DEPTH IS LESS THAN 6 INCHES.

REMOVE THE FENCE BY PULLING UP THE SUPPORT POSTS AND CUTTING THE GEOTEXTILE AT GROUND LEVEL. REGRADE OR REMOVE SEDIMENT AS NEEDED, AND STABILIZE DISTURBED SOILS.


WITH CURB DEFLECTOR NO SCALE

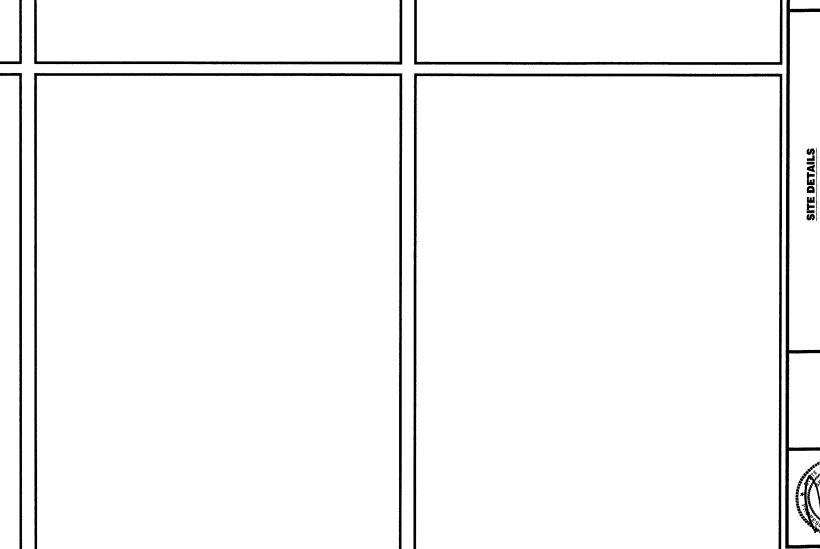

CASSIDY

જ


HALLISEY, PEARSON

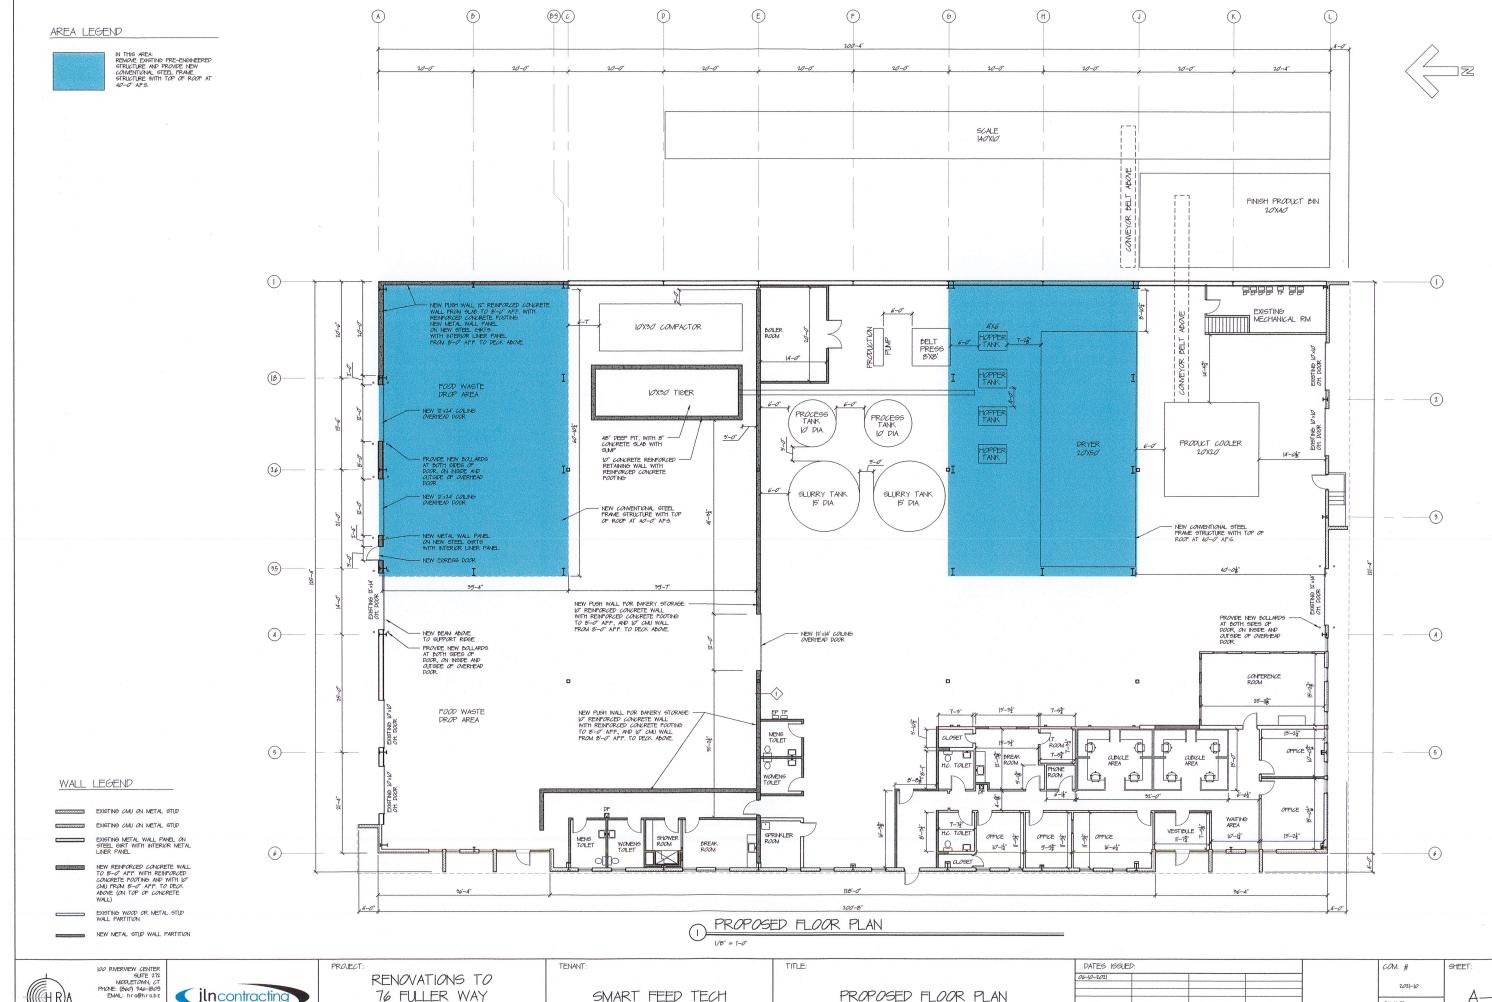



BERLIN, CT

PROPOSED FLOOR PLAN

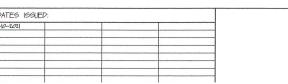

A-3SCALE: 1/8" = 1-0"

