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# Improvements to ABC Supply Co.

Parcel # 10-2-83-14
550-554 Berlin Turnpike
Berlin, Connecticut

# GI-2 PS-B DEMING RD BT-2 ZONE: BT-1 PI WETHERSELELD RD R-15

KEY MAP
SCALE: 1"=500'

# Sheet Index:

	Property & Topographic Survey Map (1"=80' Scale)
S1	Overall Site Plan (1"=60' Scale)
C1-2	Site Layout Plan & Landscaping Plan (1"=40' Scale)
U1-2	Site Utility Plan (1"=40' Scale)
G1-2	Site Grading Plan (1"=40' Scale)
P1	Entrance Driveway - Plan & Profile
ES1-2-3	Soil Erosion & Sedimentation Control Plan (1"=40' Scale)
ES4	Soil Erosion & Sedimentation Control Details
D1	Details
M1	Mitigation Plan - Flood Storage

# Applicant:

550-554 Berlin Turnpike Assoc. LLC 864 Wethersfield Avenue Hartford, CT 06114

# Property Owner:

550-554 Berlin Turnpike Assoc. LLC 864 Wethersfield Avenue Hartford, CT 06114

# Consultants:

# **Engineering & Surveying**

Harry E. Cole & Son P.O. Box 44 - 876 South Main Street Plantsville, Connecticut 06489 Tel. (860) 628-4484 Fax (860) 620-0196

# Soil Scientist

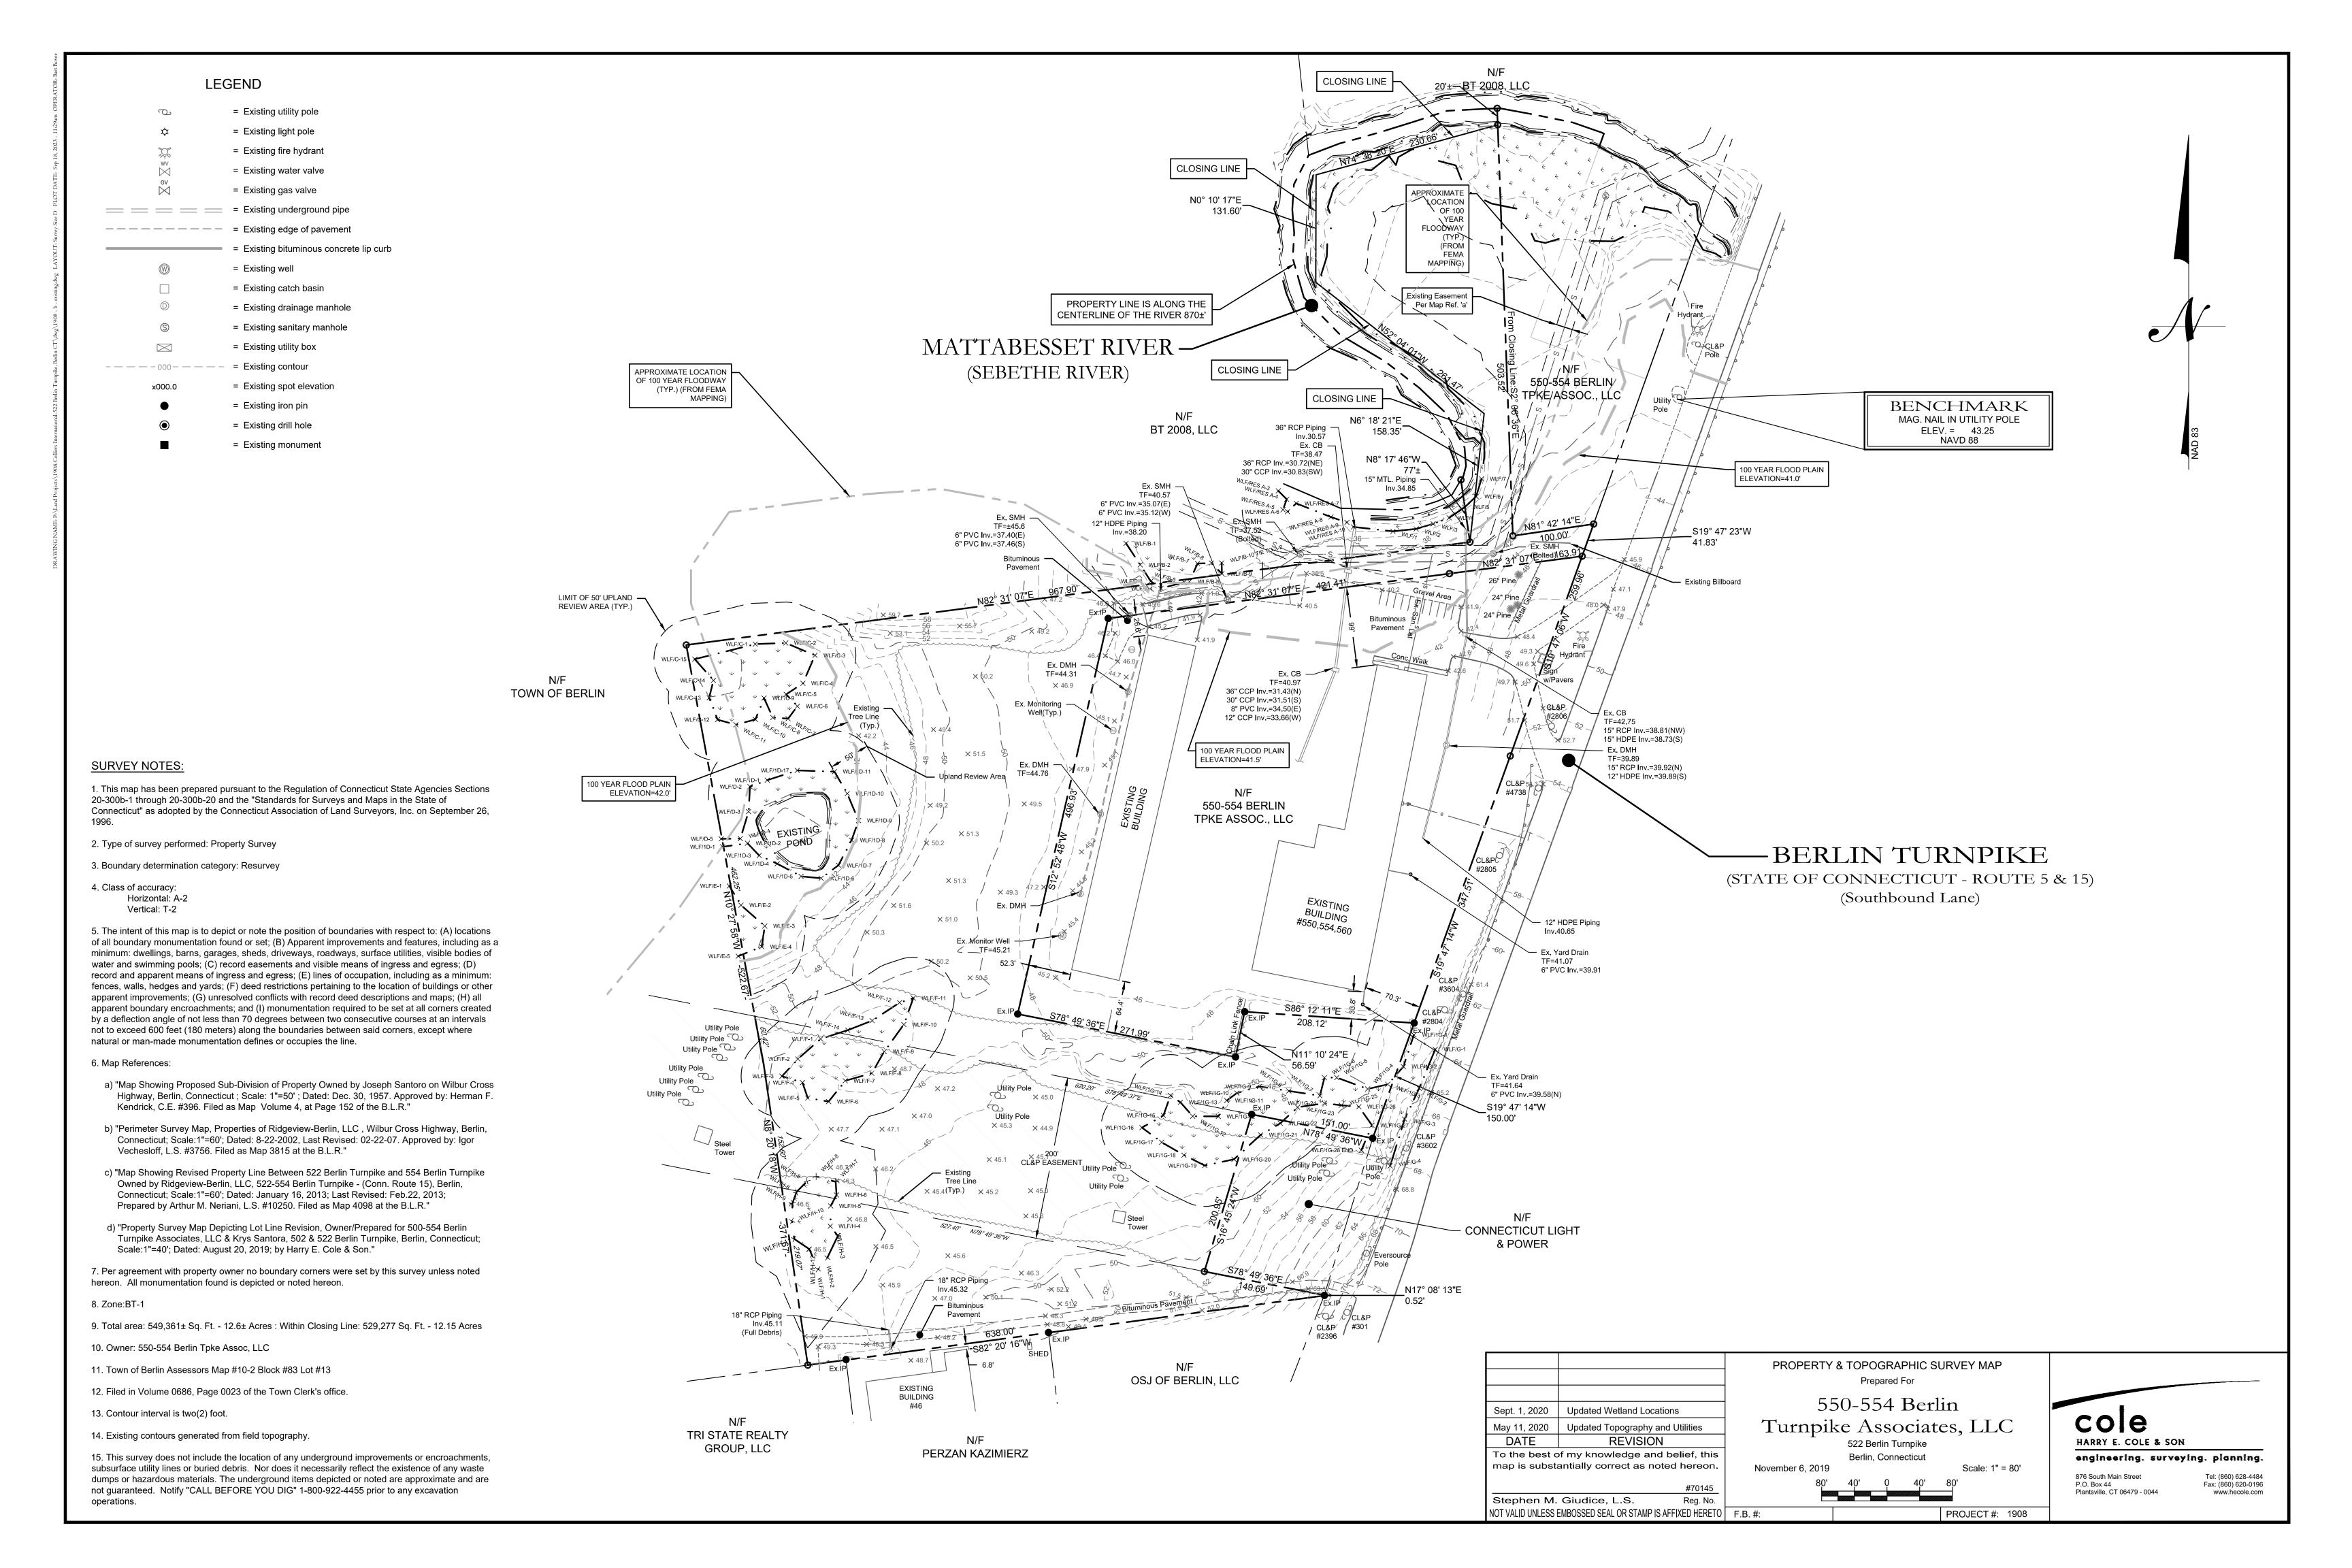
George T. Logan MS, PWS, CSE REMA Ecological Services, LLC 164 East Center Street, Suite 8 Manchester, CT 06040 (860) 649-7362

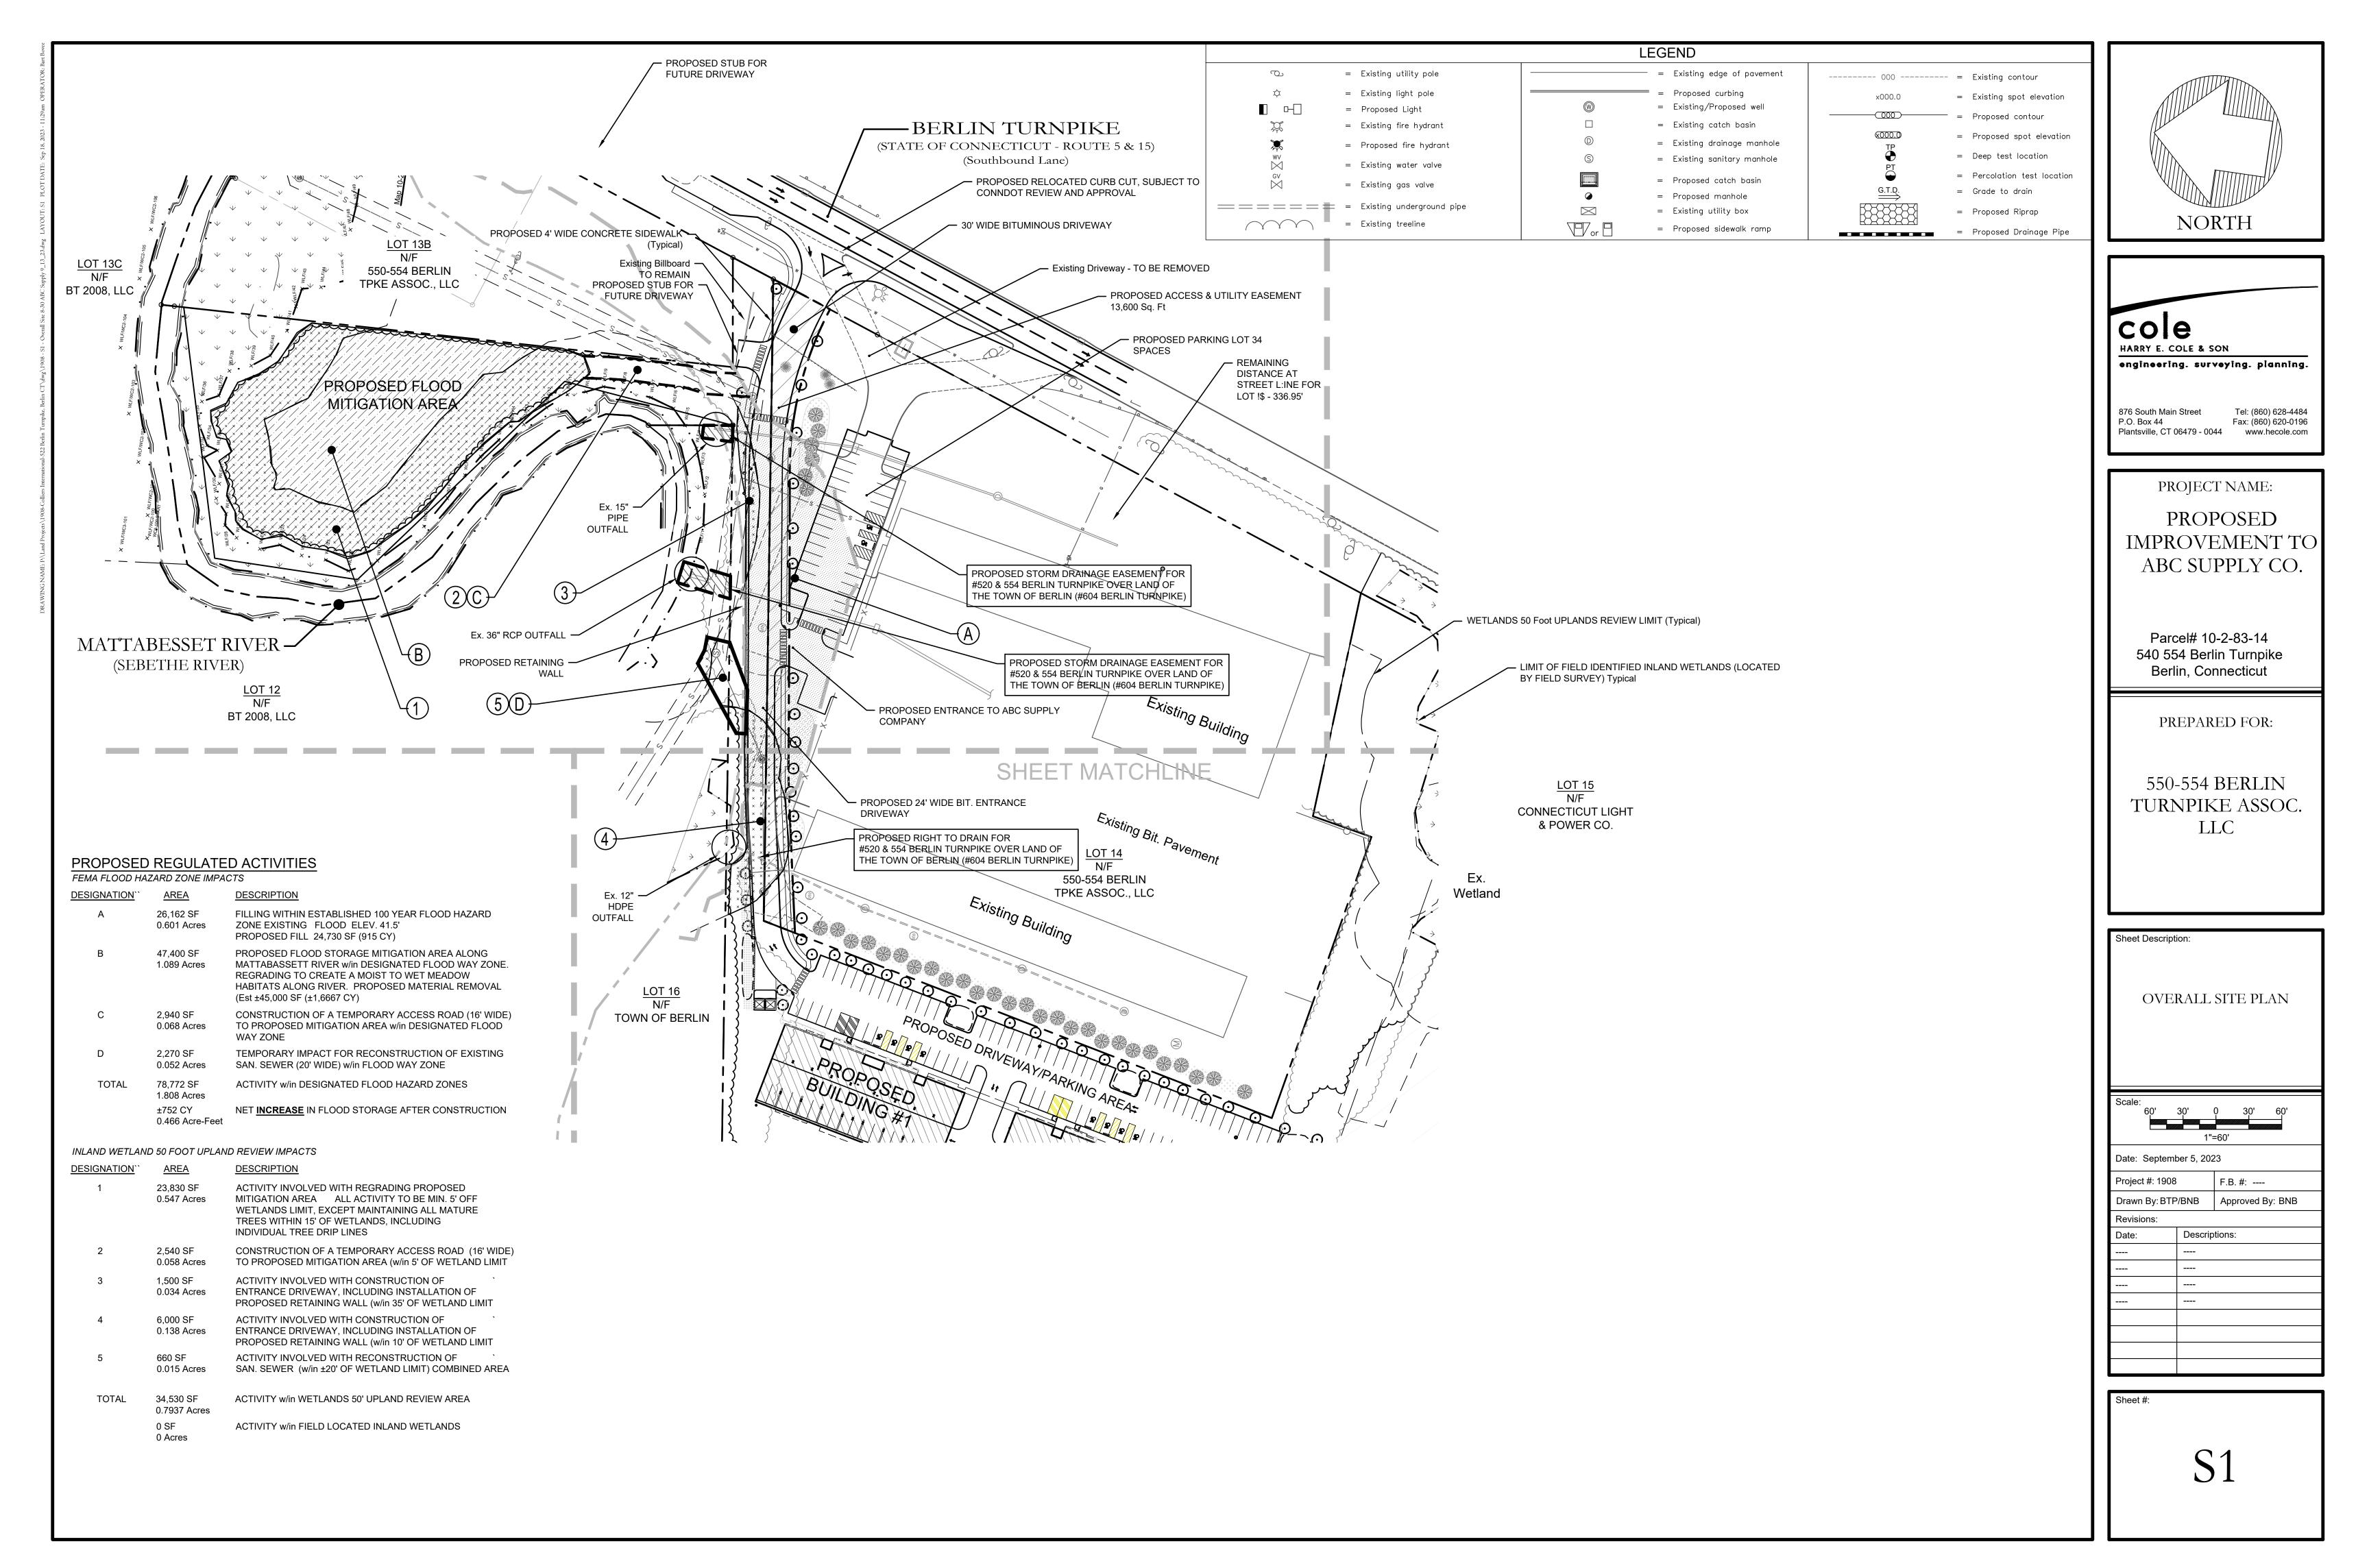
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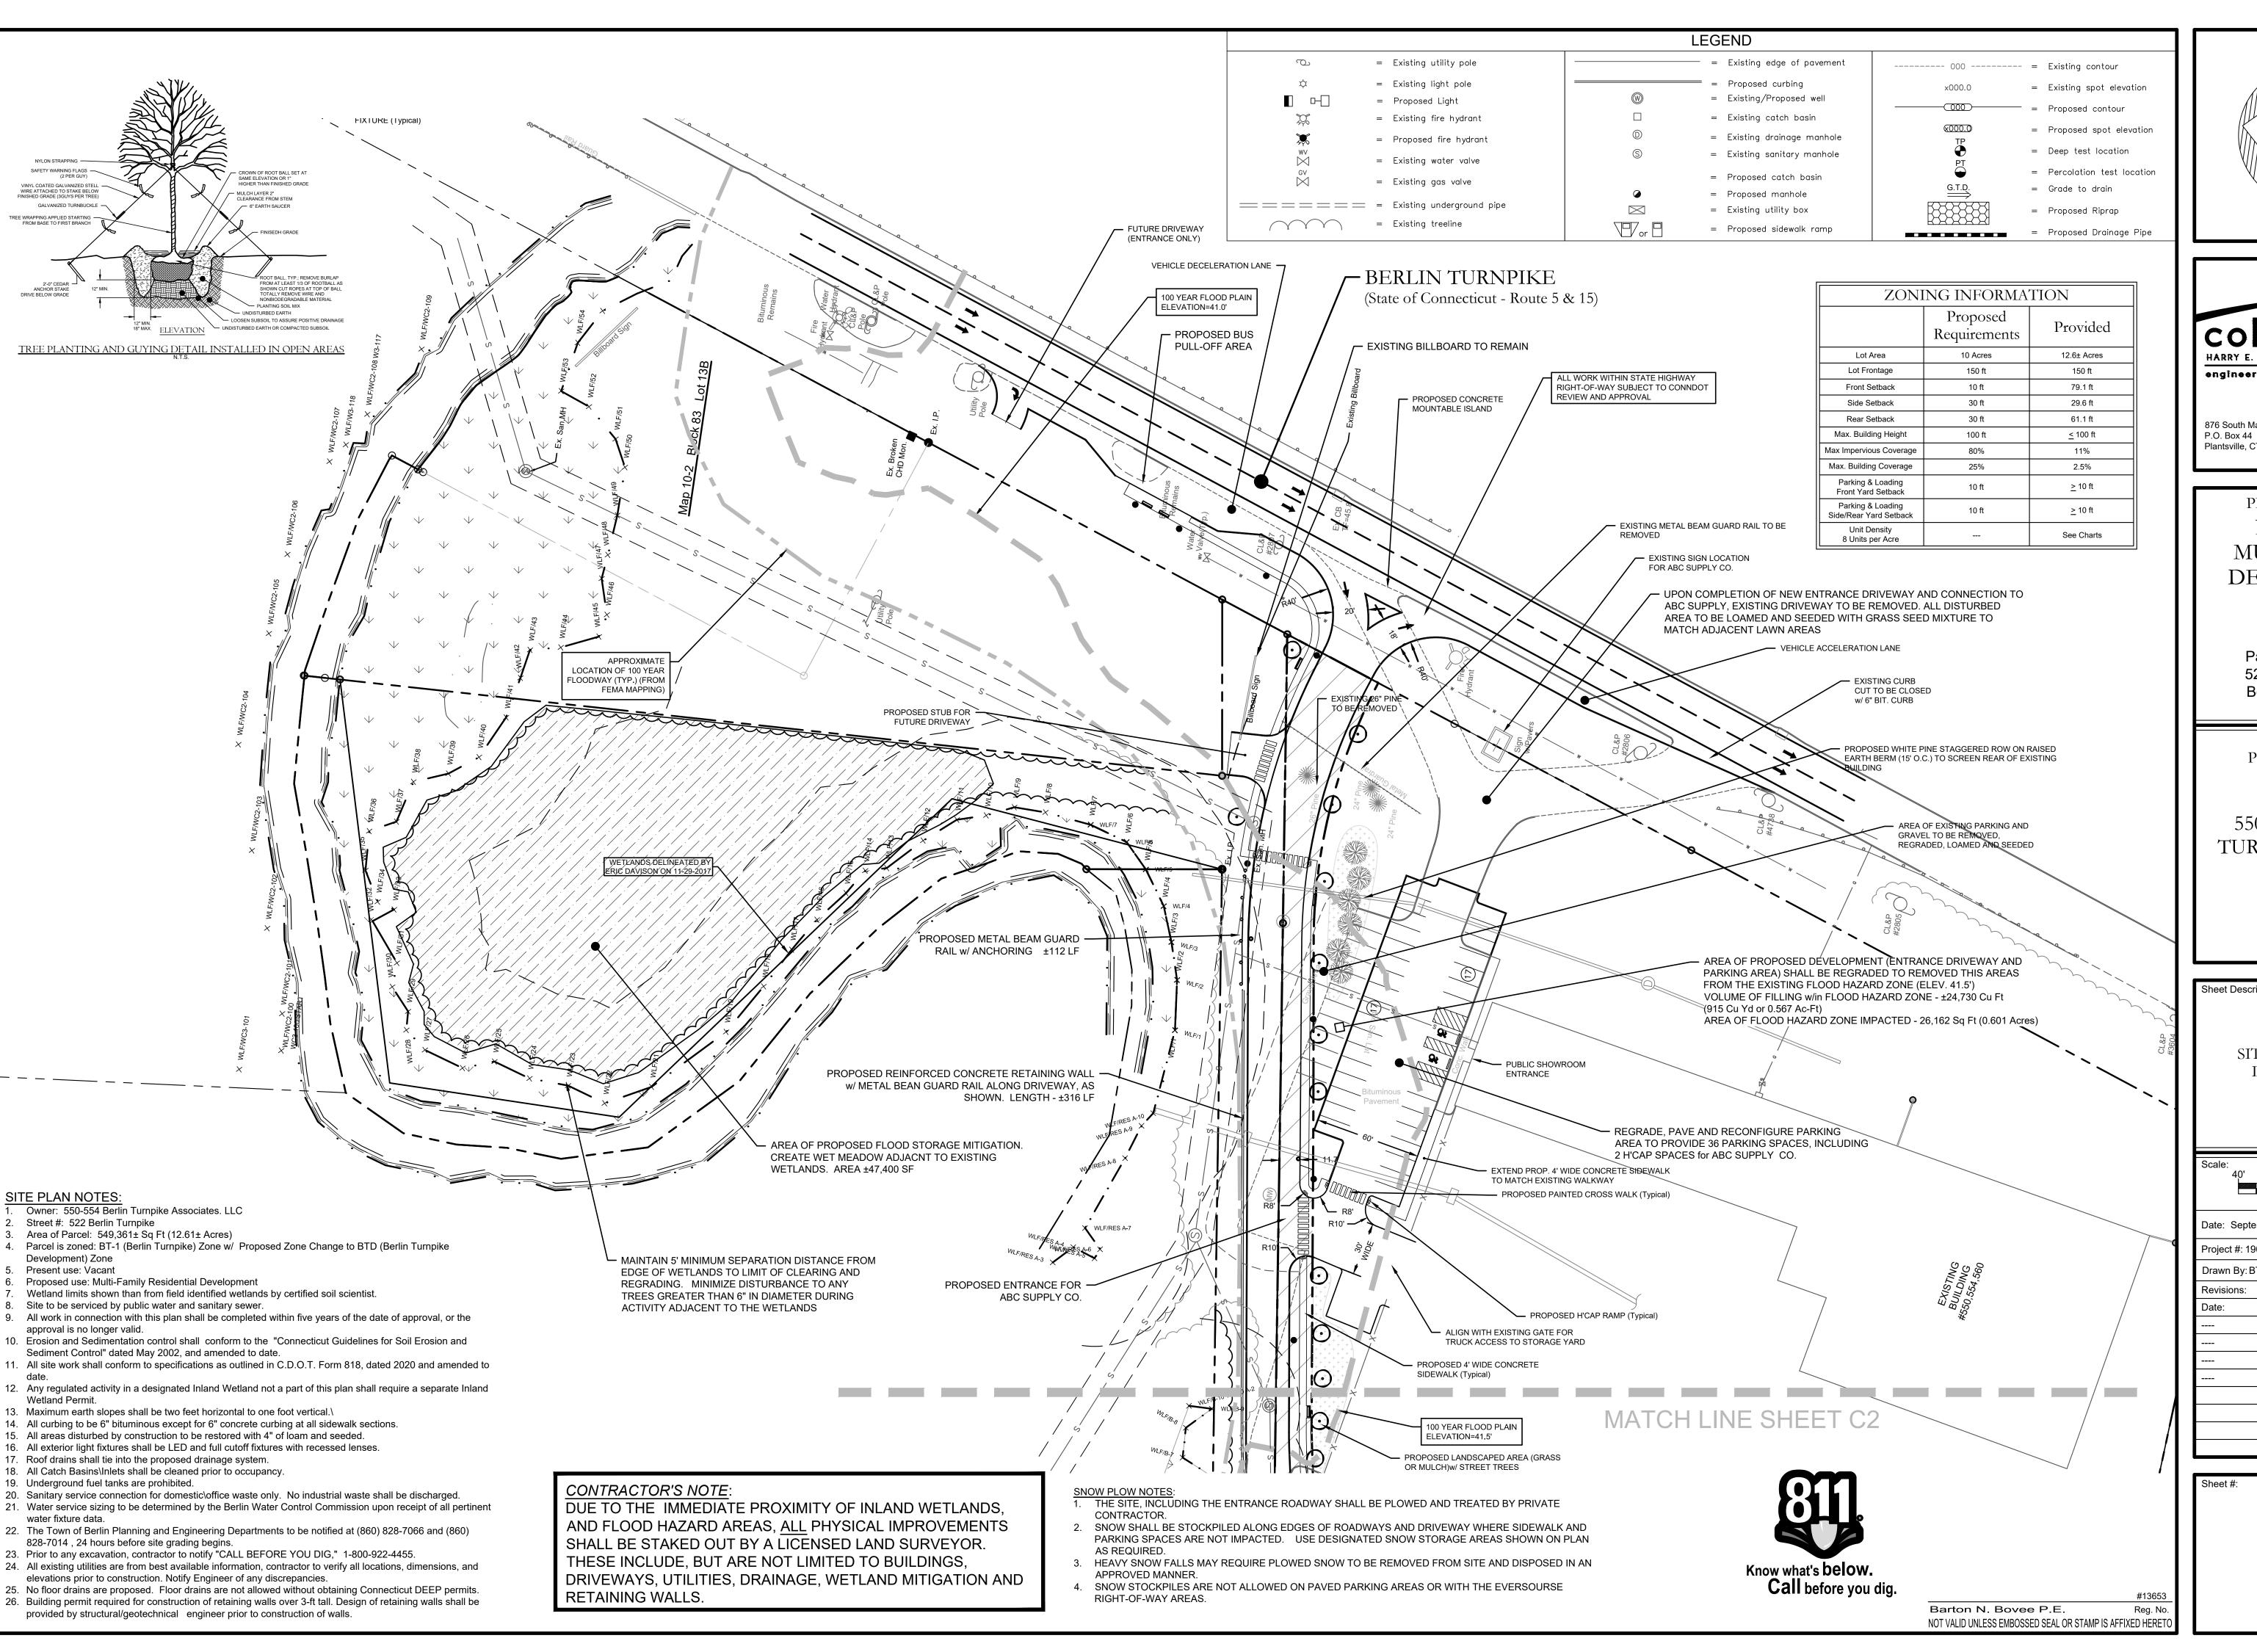
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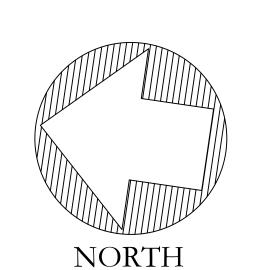
September 5, 2023

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	Sept. 5, 2023	PZC Submission	#1908









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> PROJECT NAME: **PROPOSED MULTI-FAMILY** DEVELOPMENT

Parcel# 10-2-83-13 522 Berlin Turnpike Berlin, Connecticut

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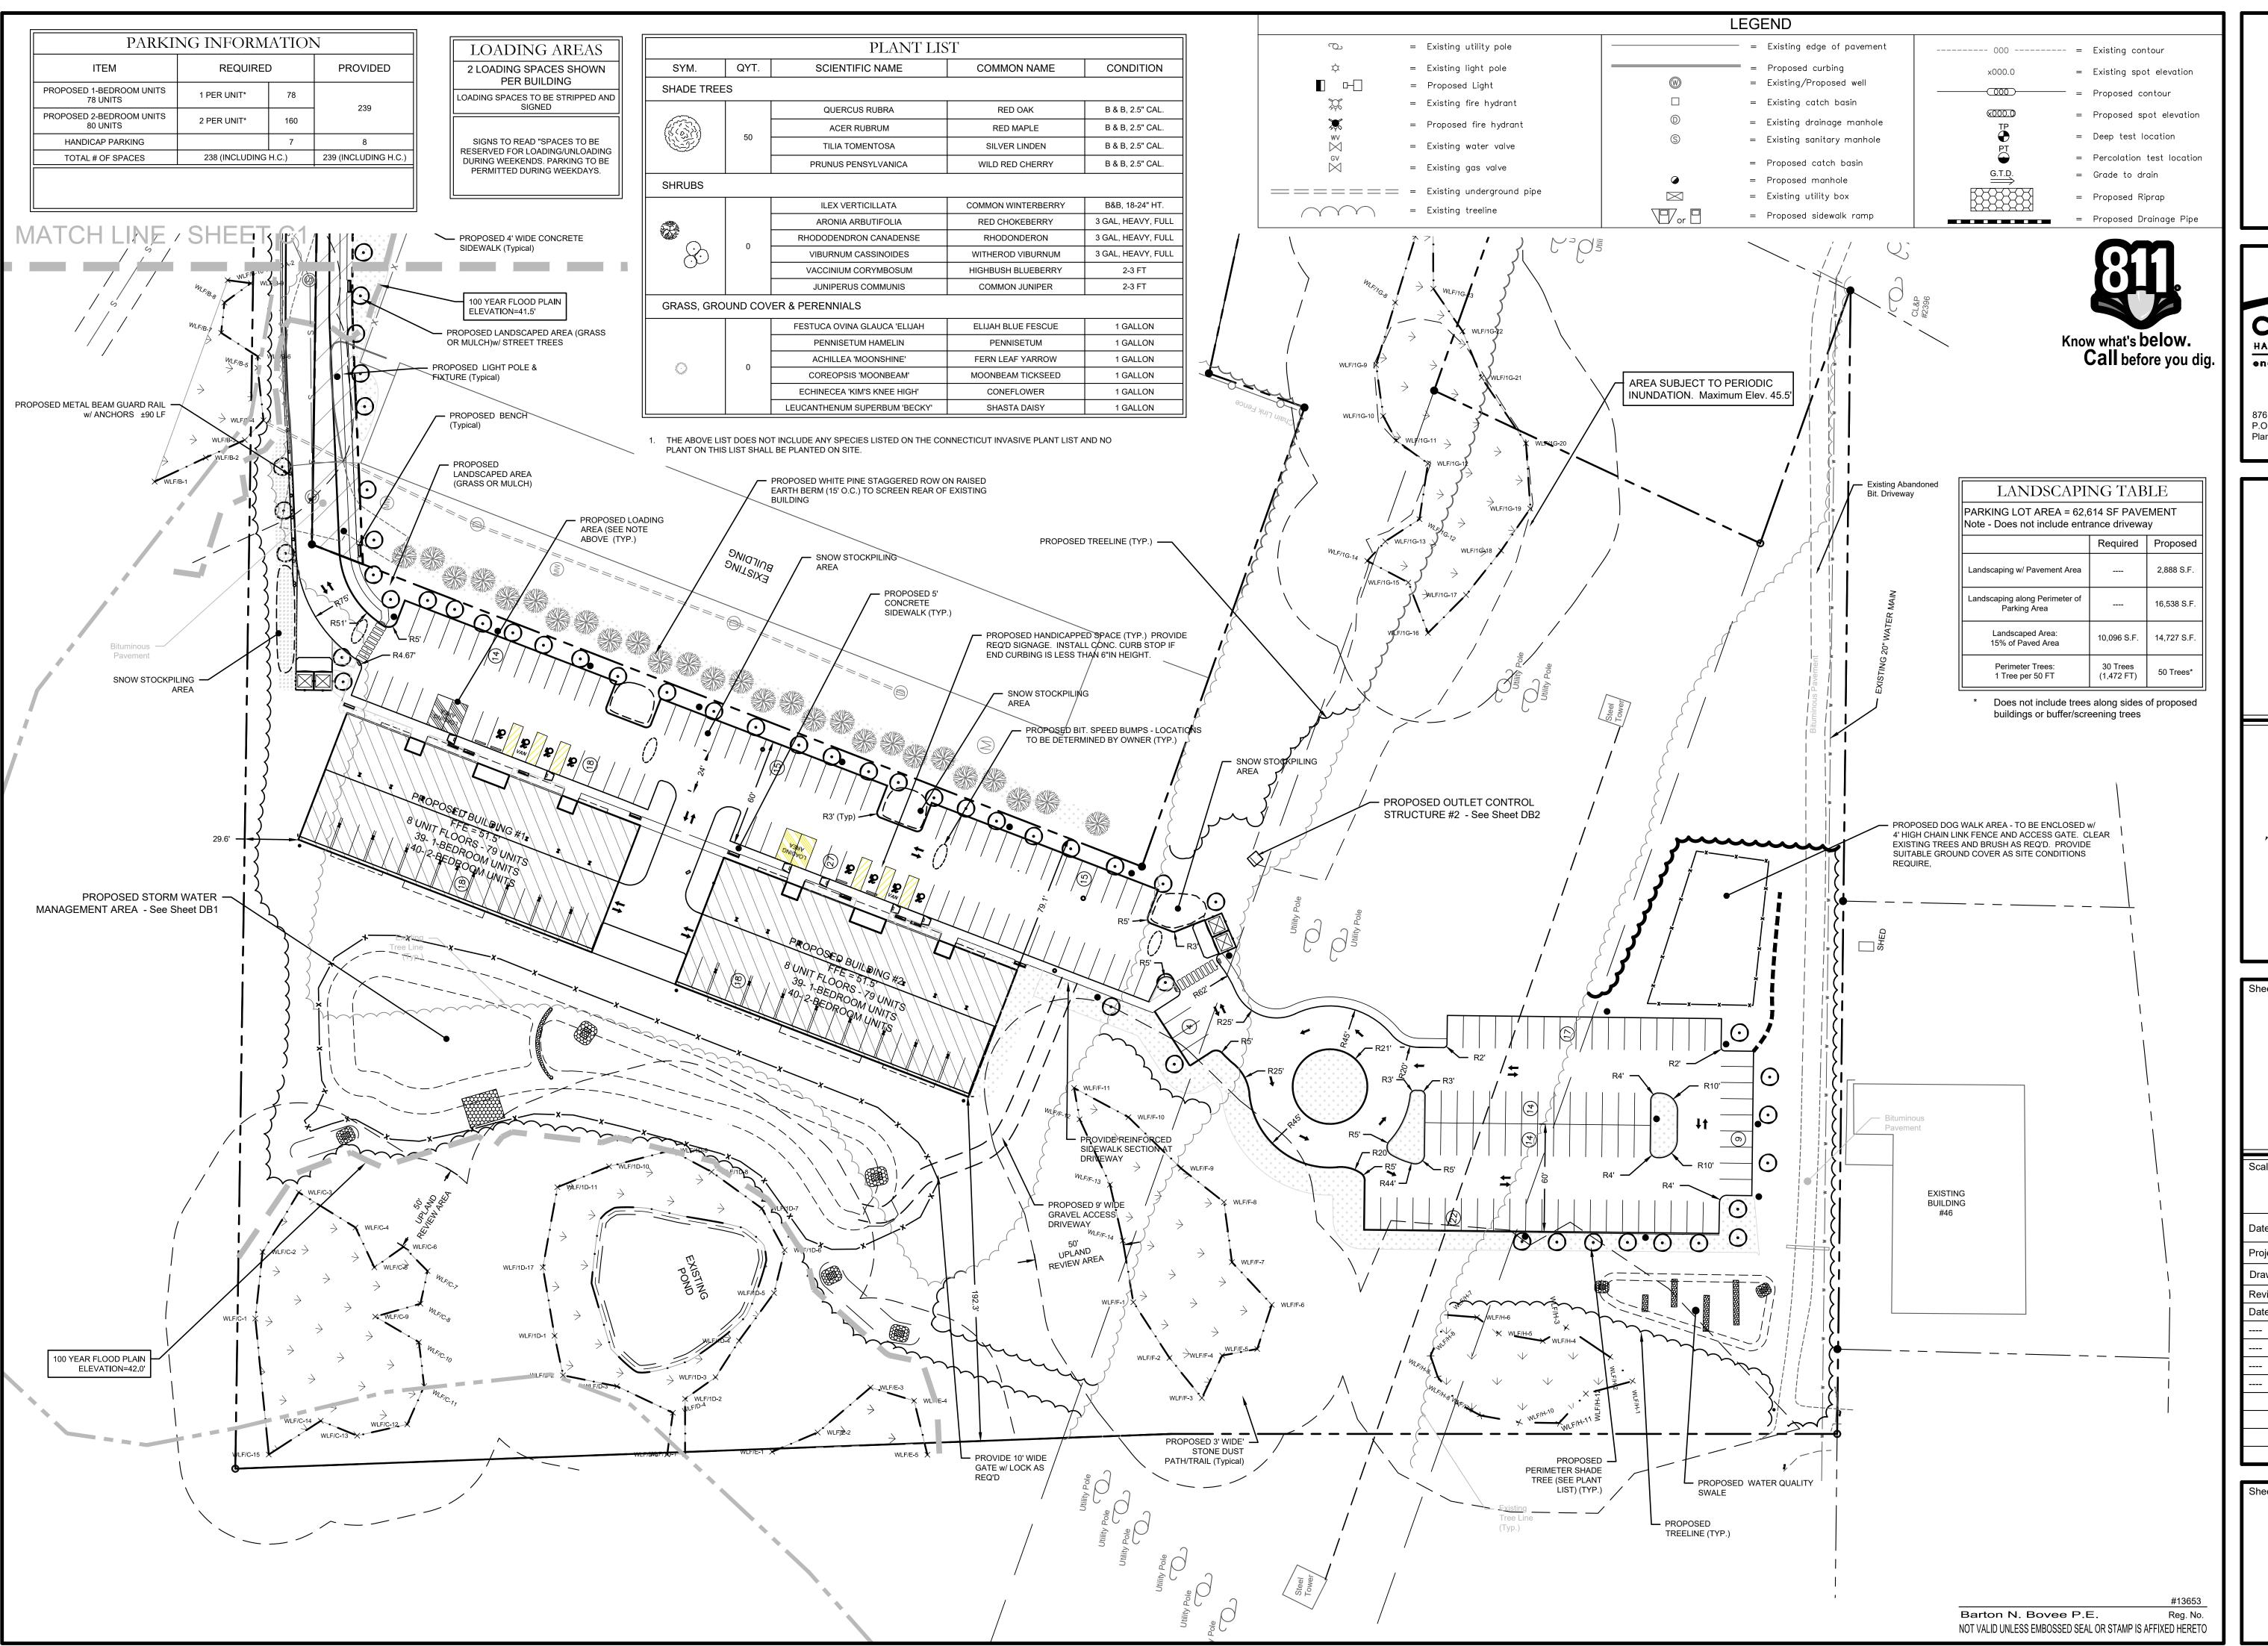
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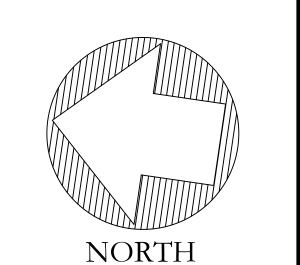
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SITE LAYOUT AND LANDSCAPING

Date: September 5, 2023

Project #: 1908 F.B. #: ----Approved By: BNB Descriptions:







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> Parcel# 10-2-83-13 522 Berlin Turnpike Berlin, Connecticut

PREPARED FOR:

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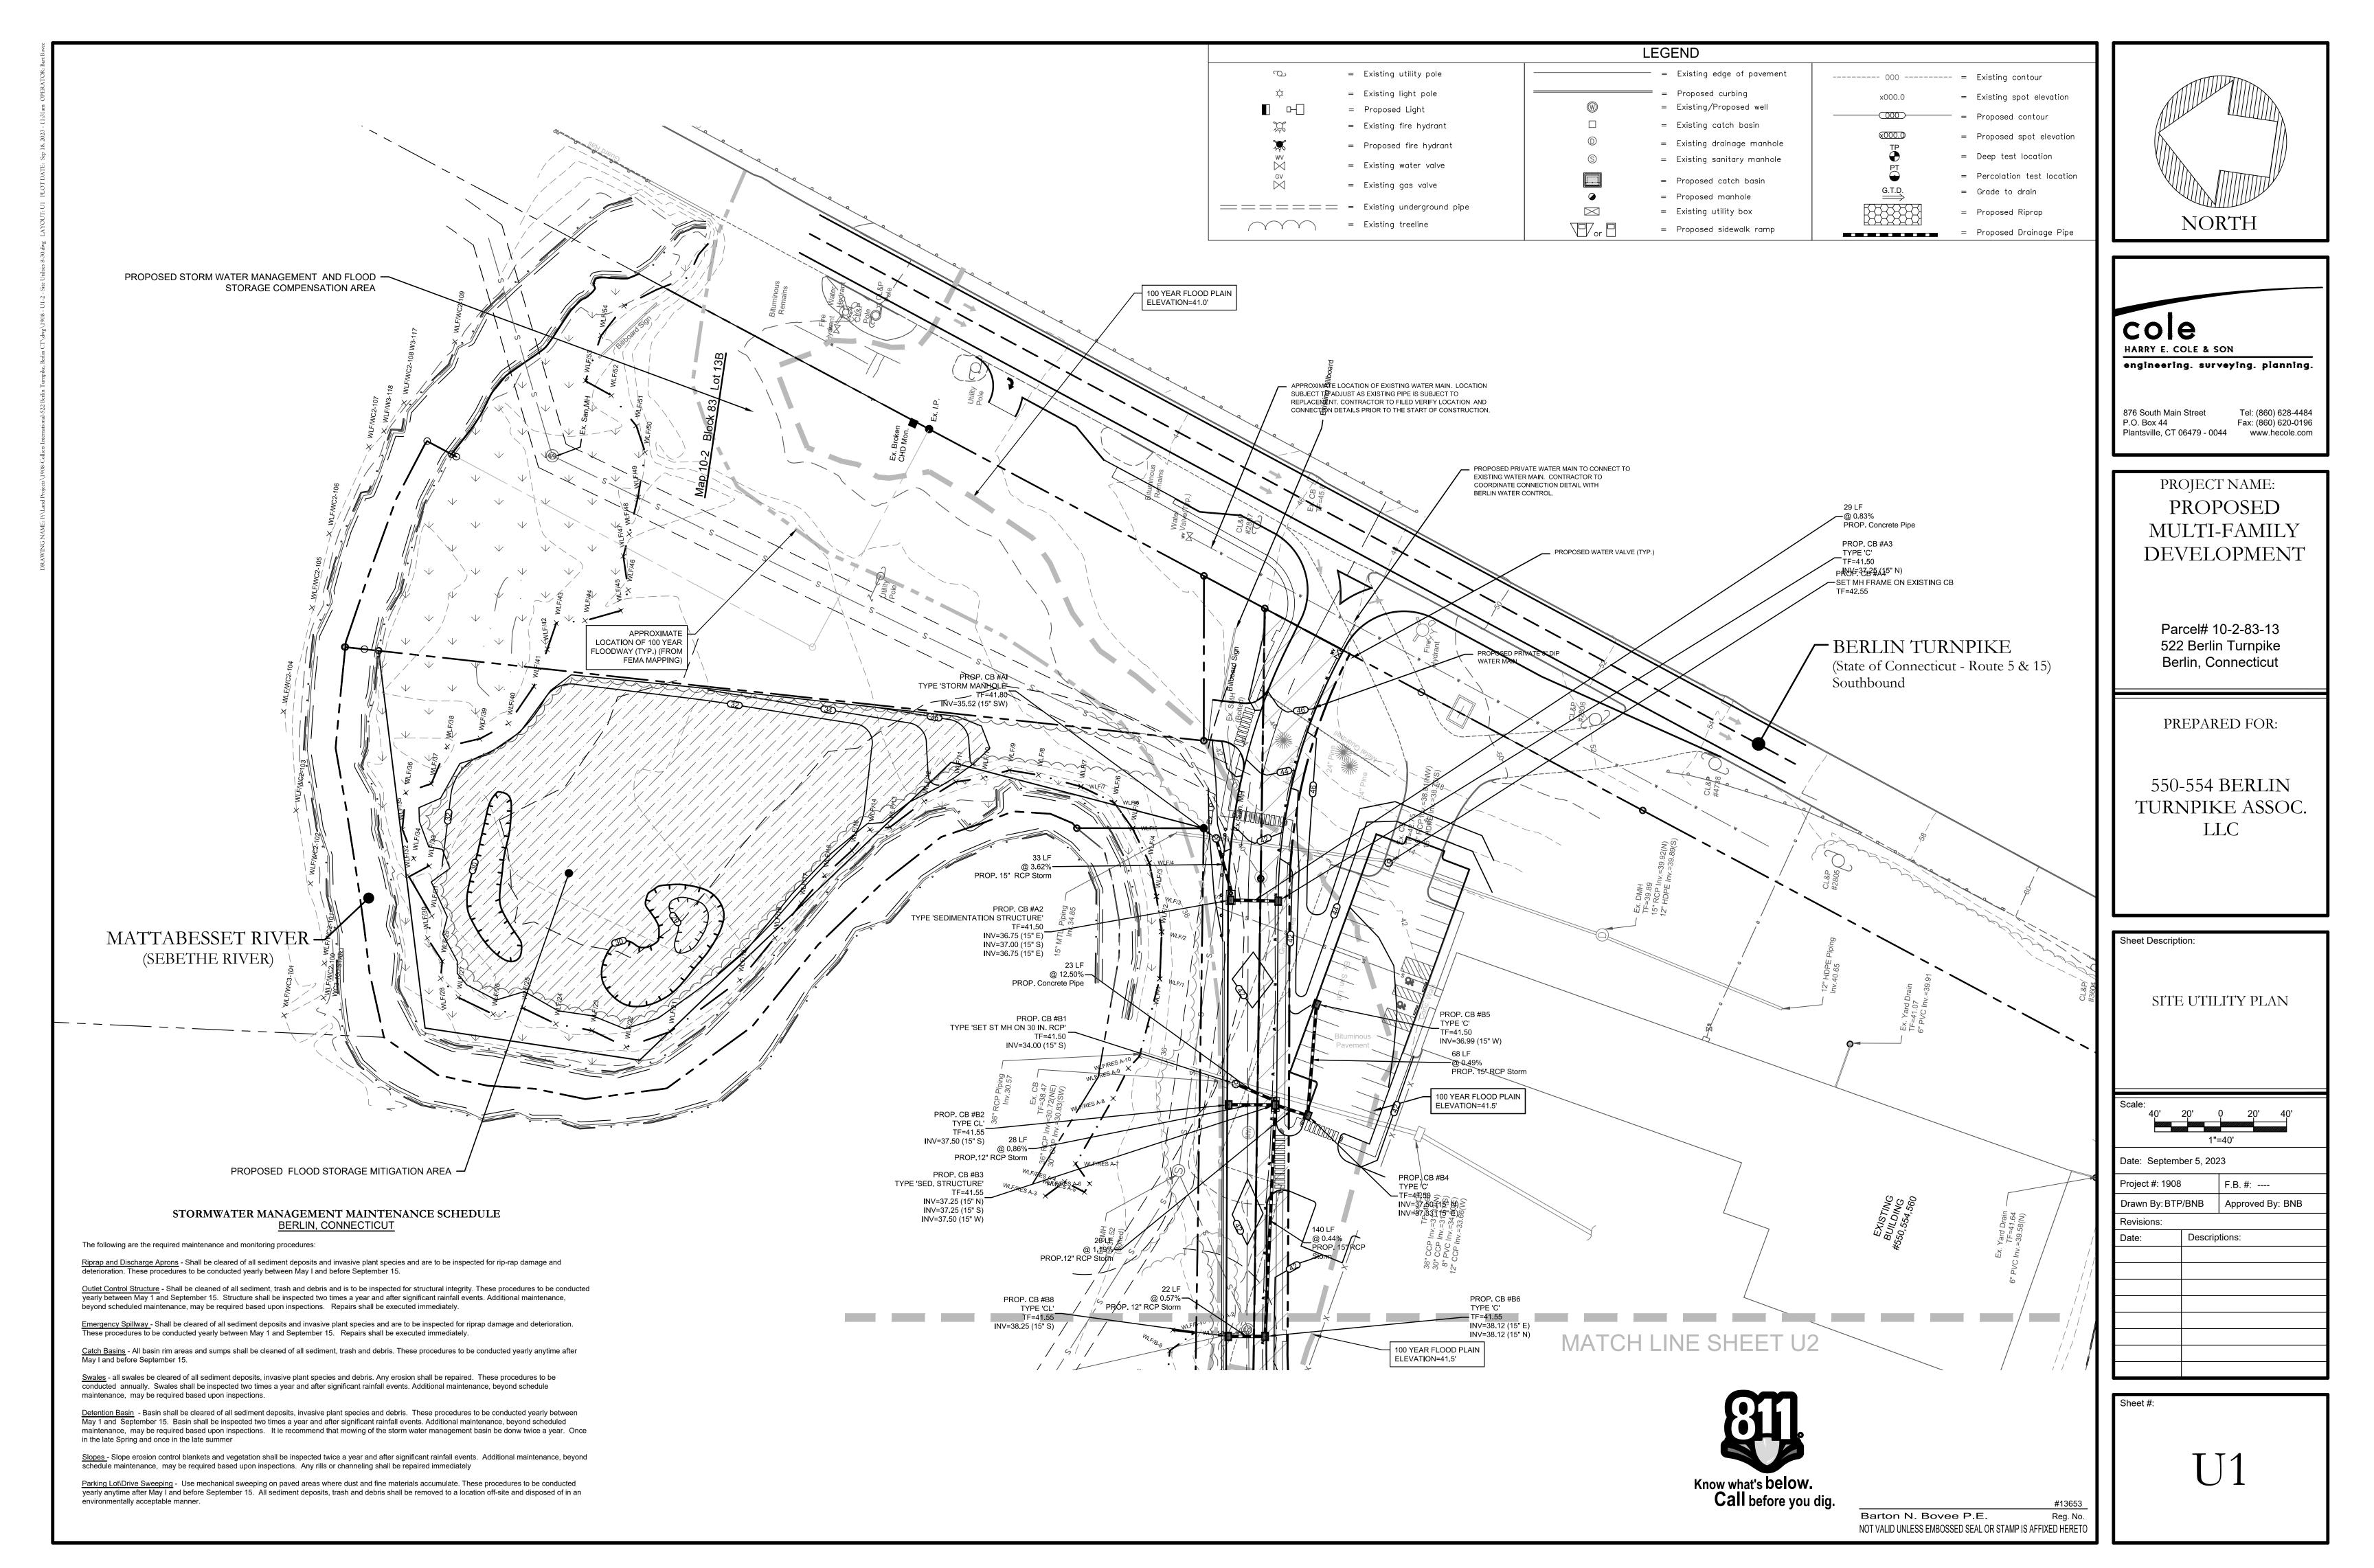
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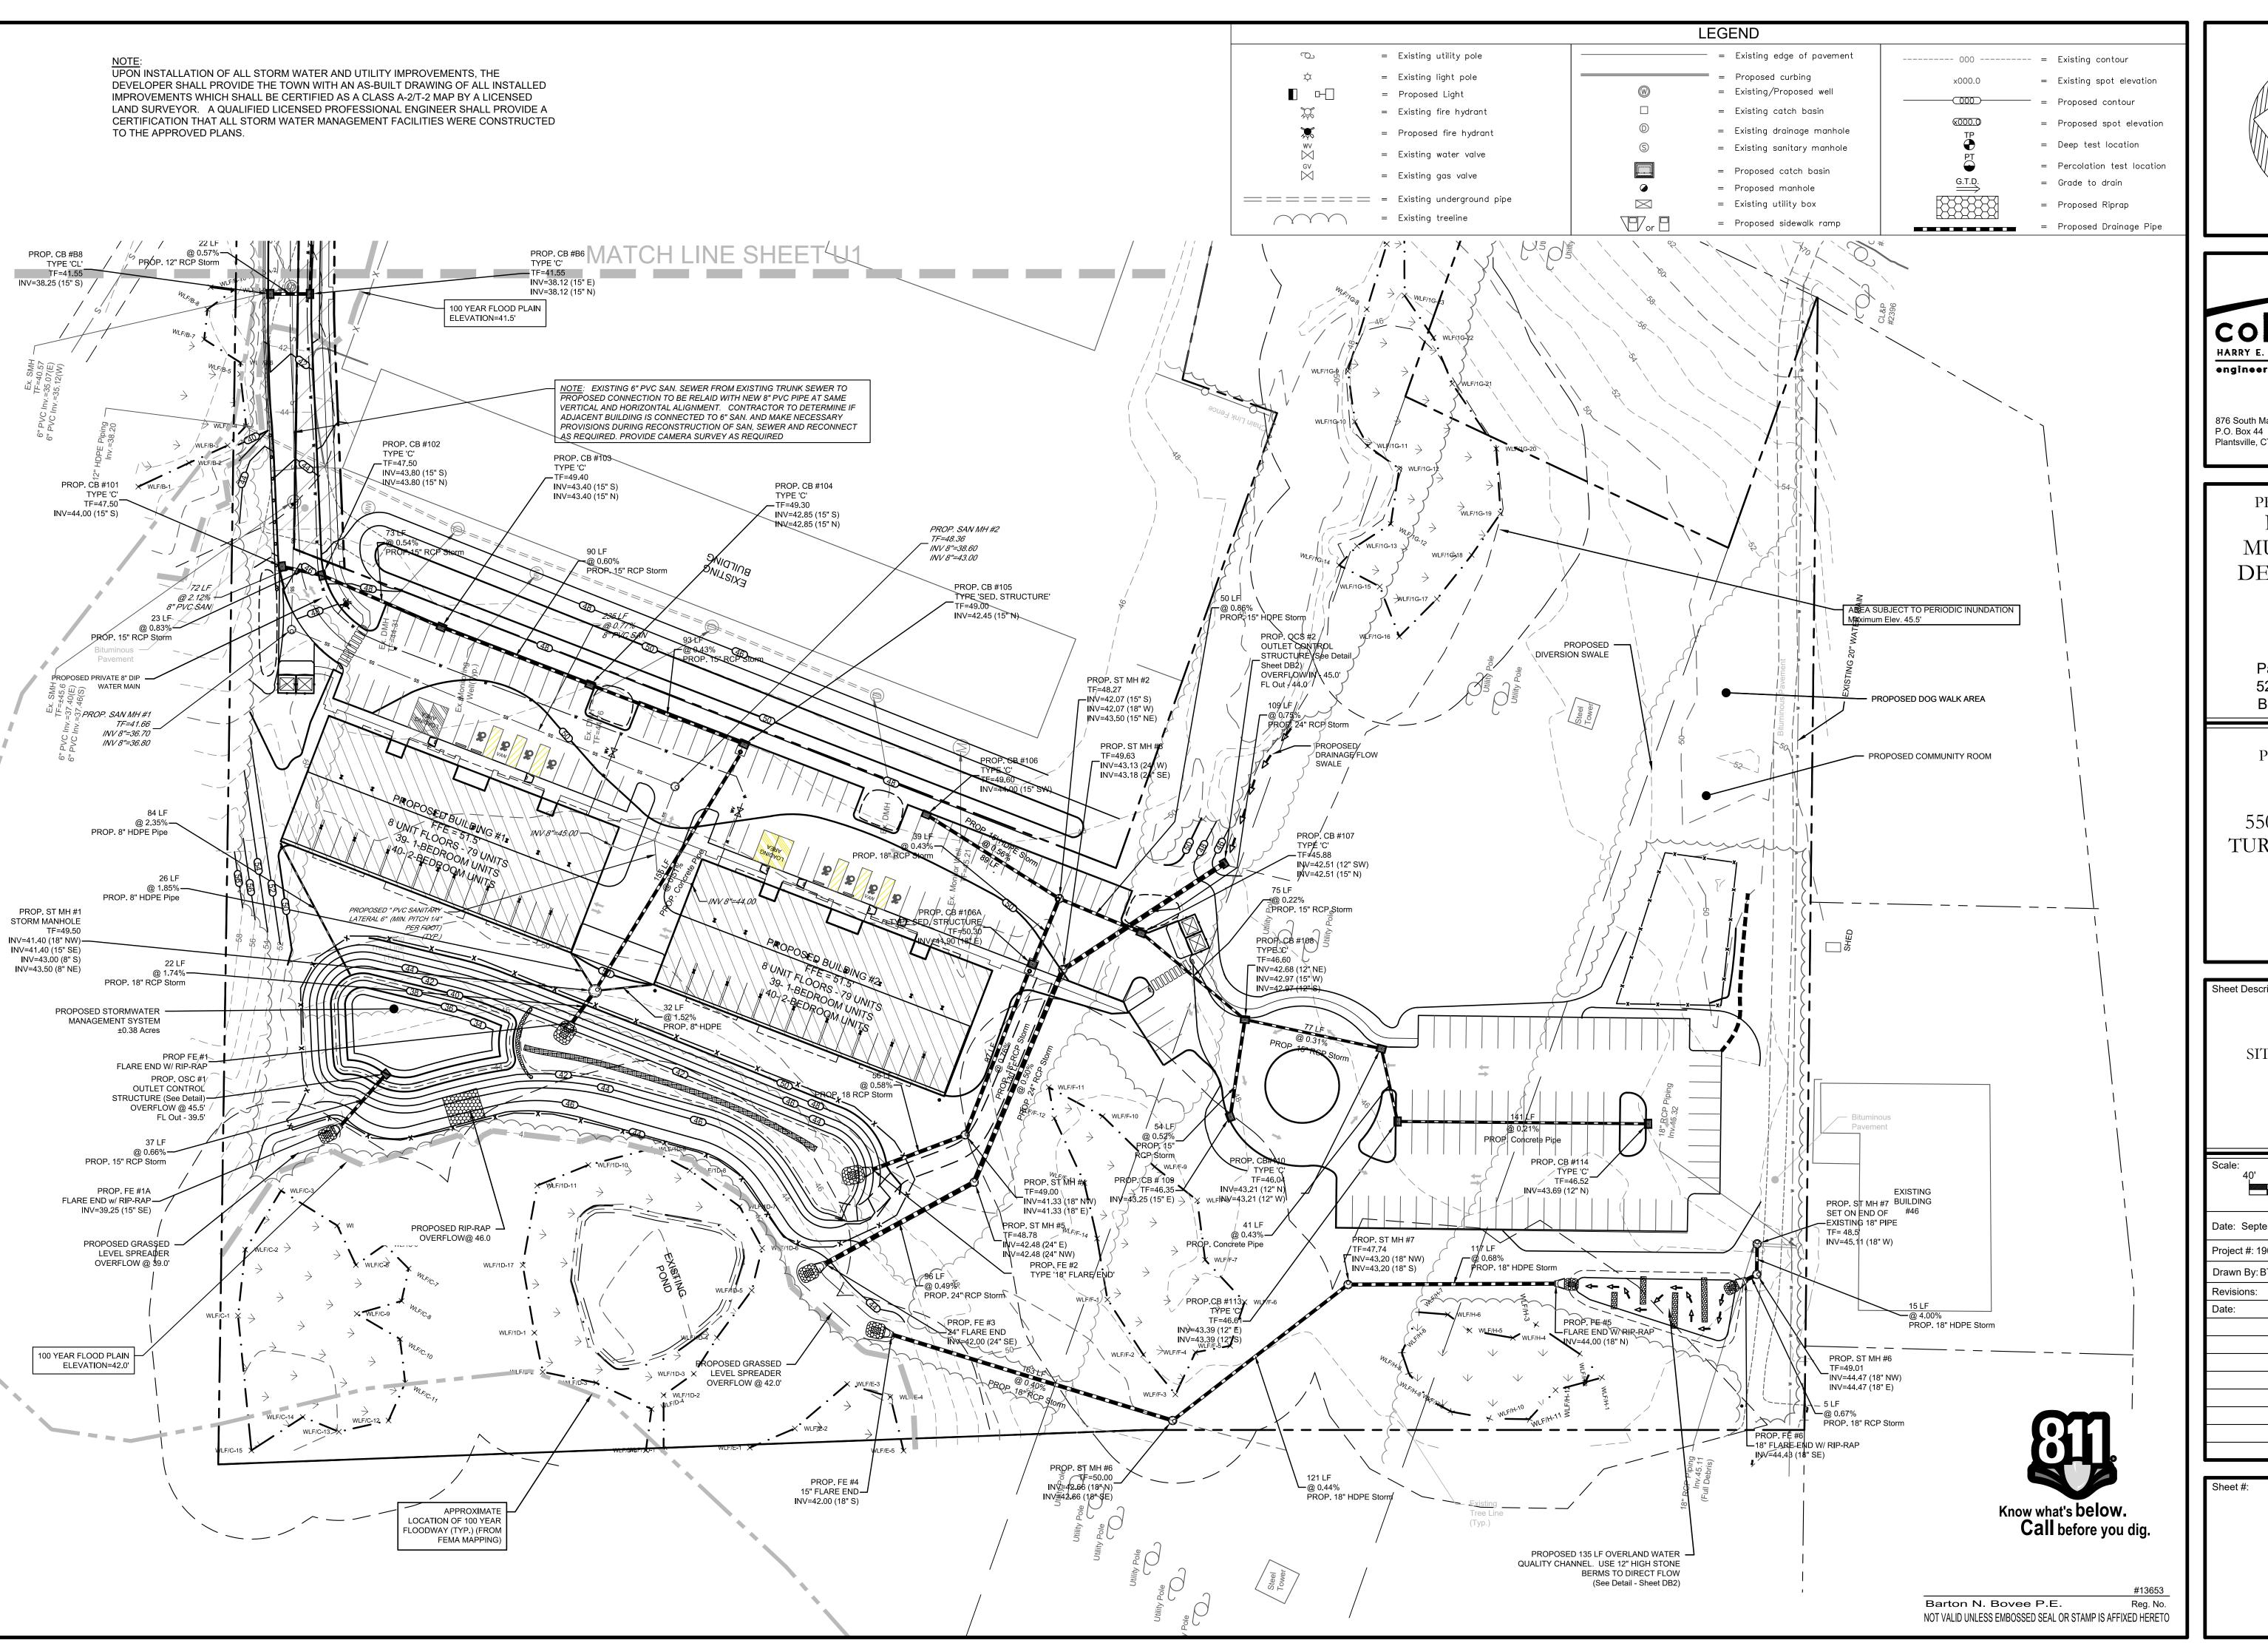
SITE LAYOUT AND LANDSCAPING

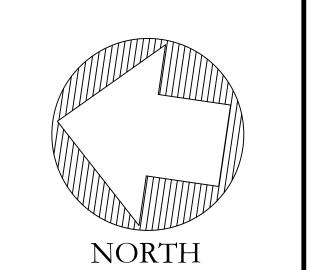
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1"=	=40'
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Drawn By: BTP/BNB	Approved By: BNB

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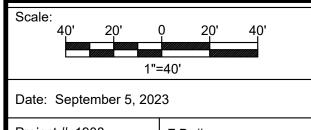
Parcel# 10-2-83-13 522 Berlin Turnpike Berlin, Connecticut

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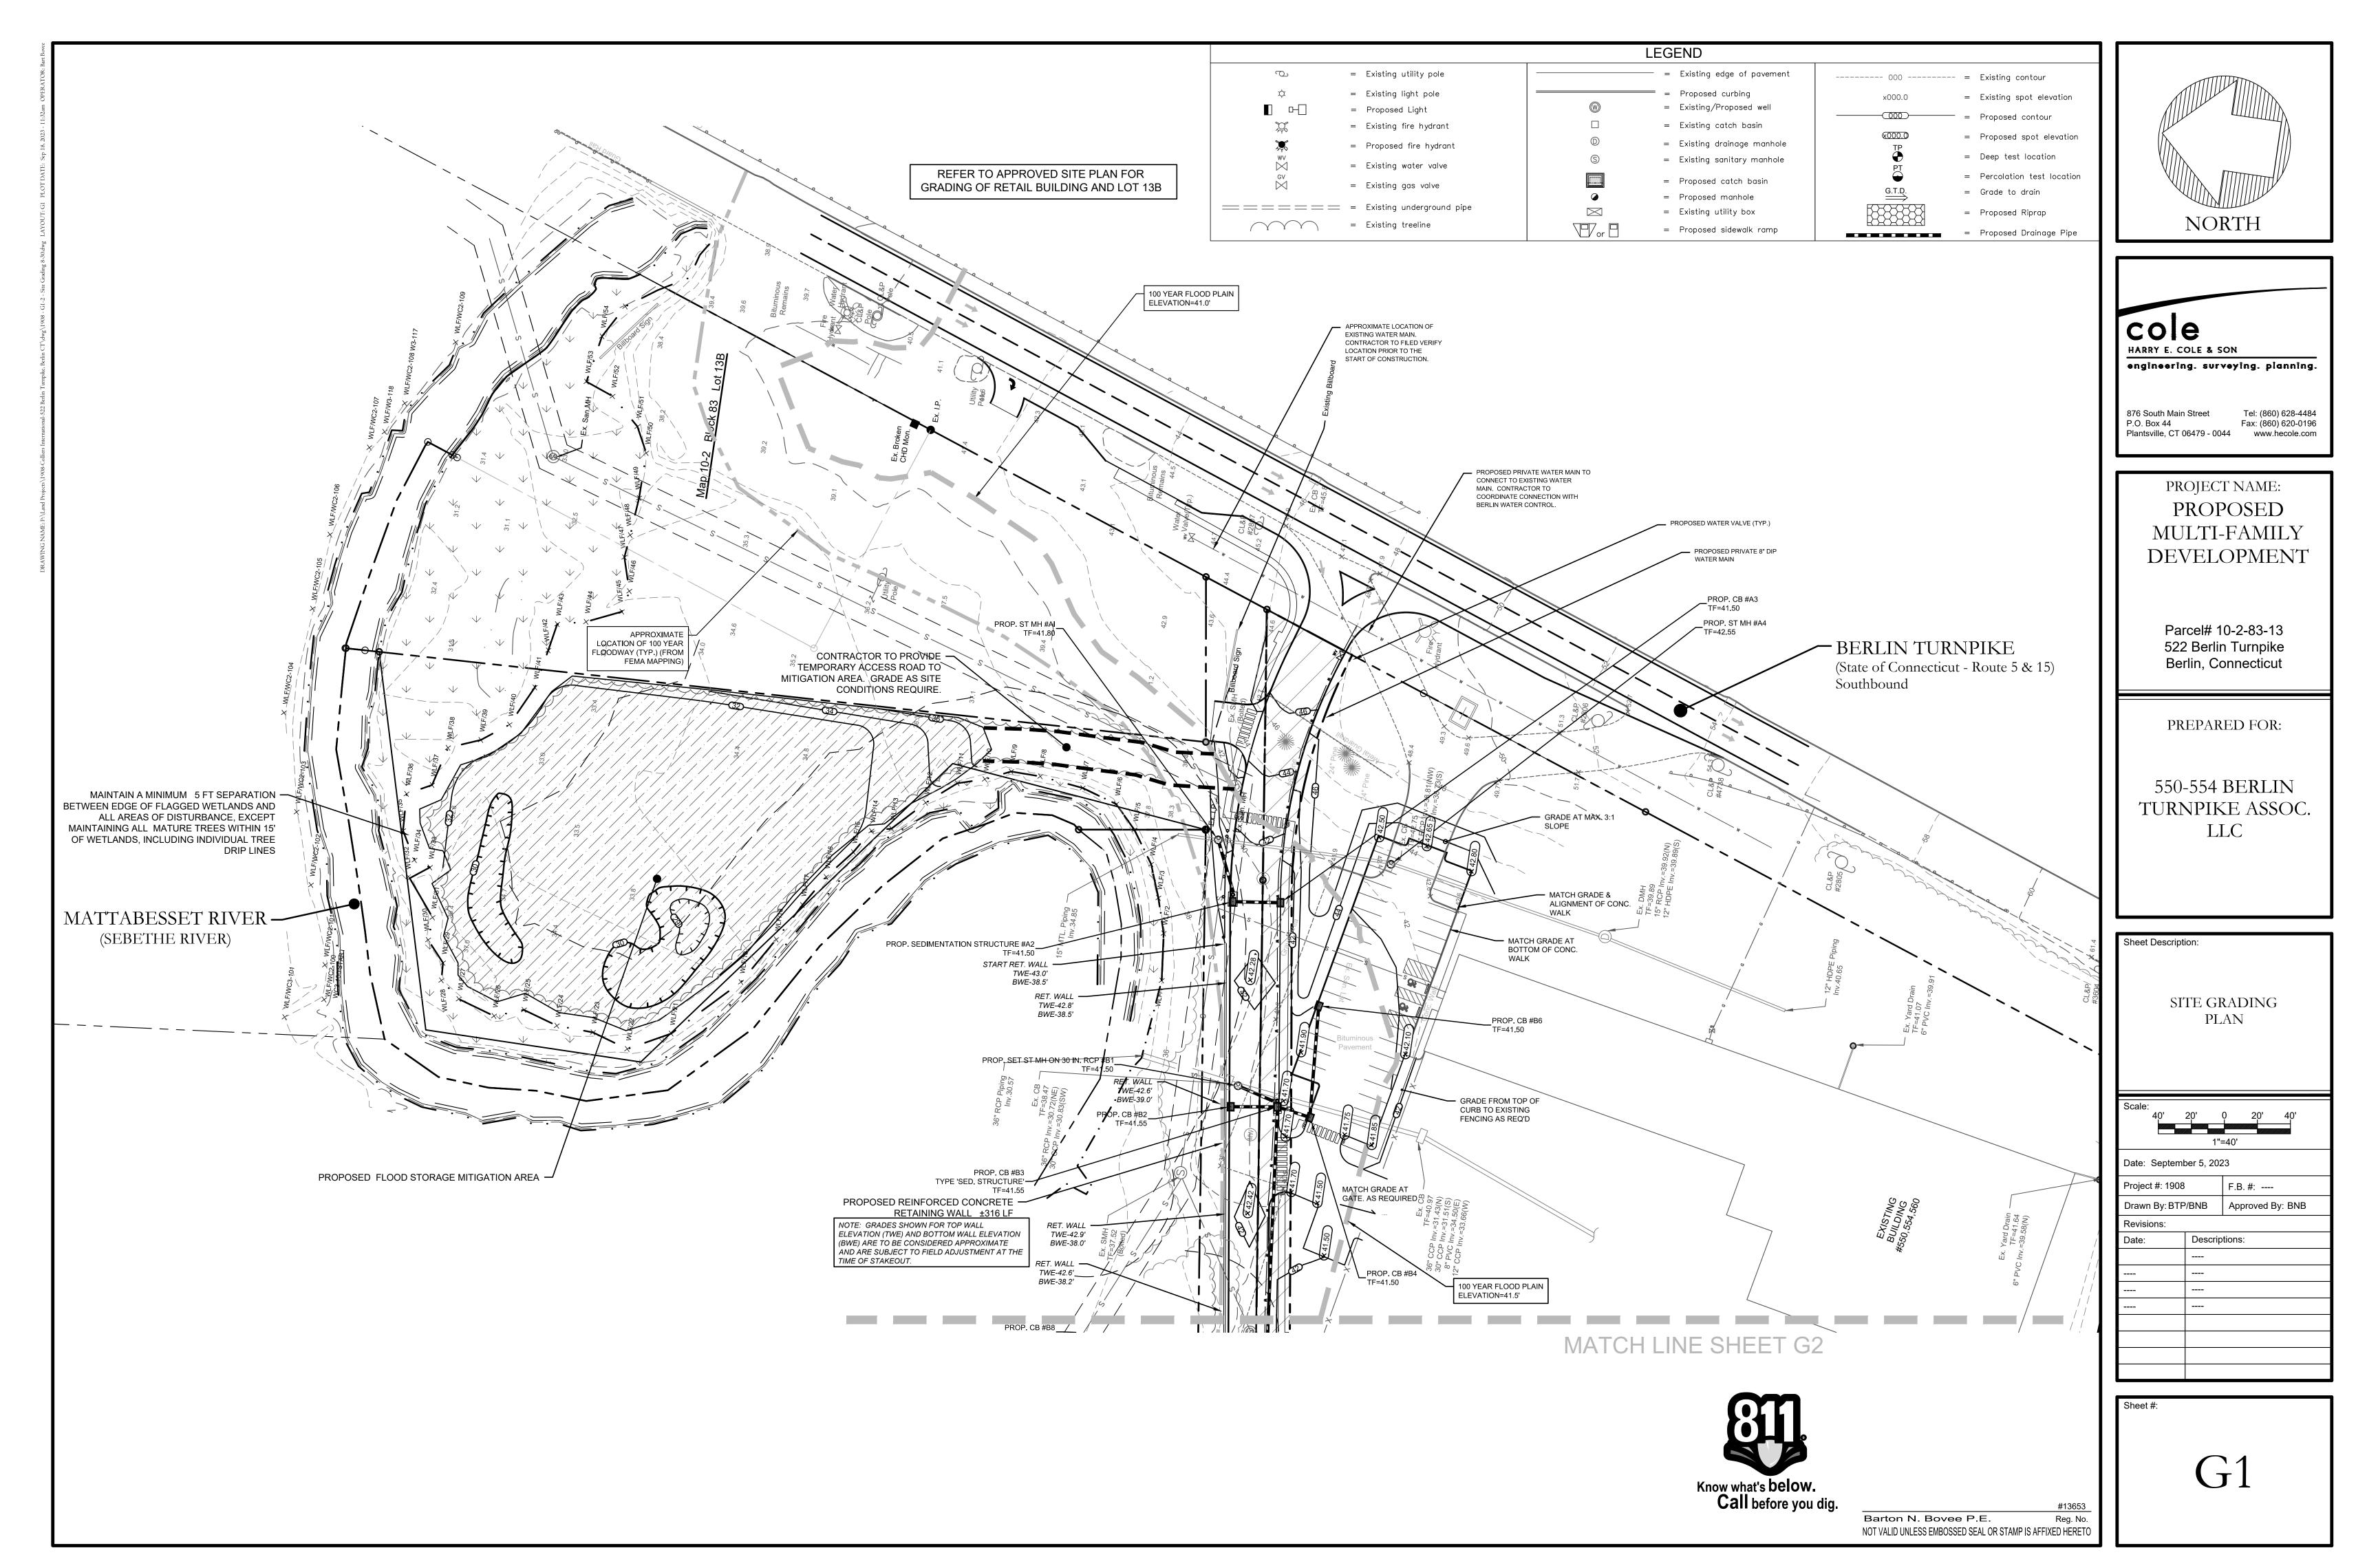
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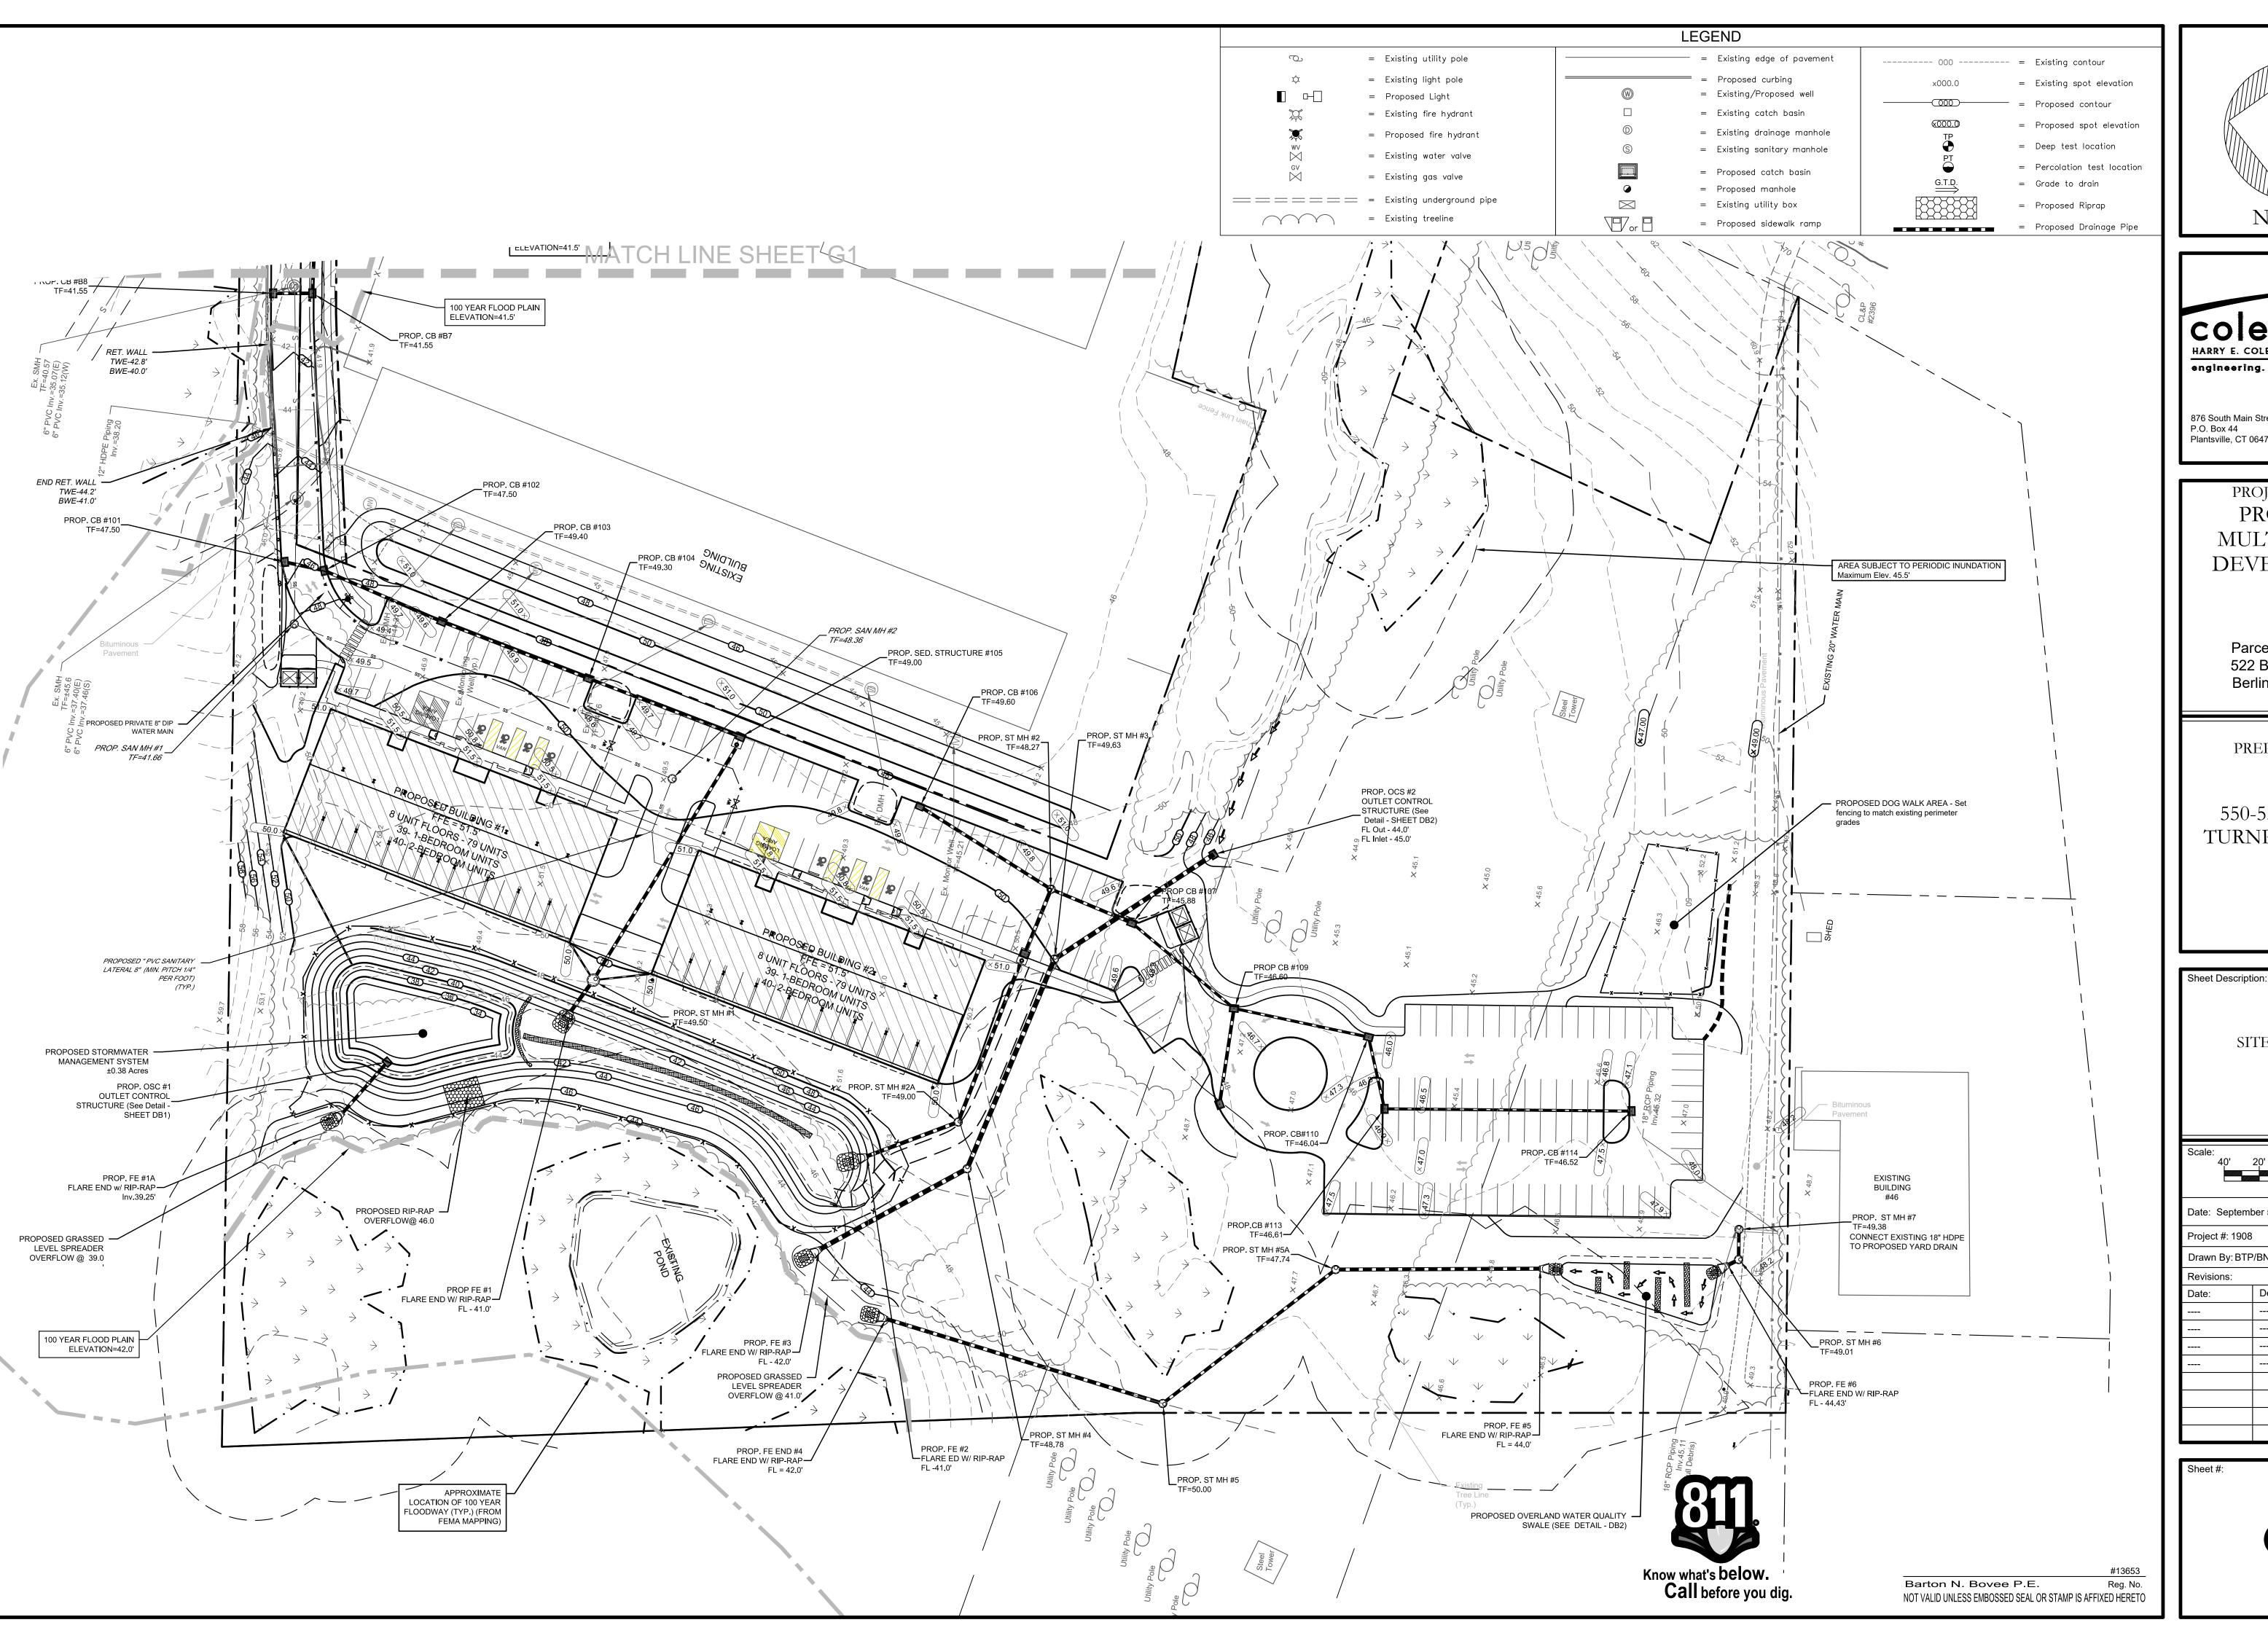
SITE UTILITY PLAN

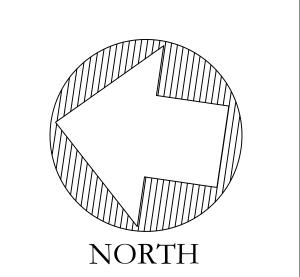


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Descriptions:









PROJECT NAME:
PROPOSED
MULTI-FAMILY
DEVELOPMENT

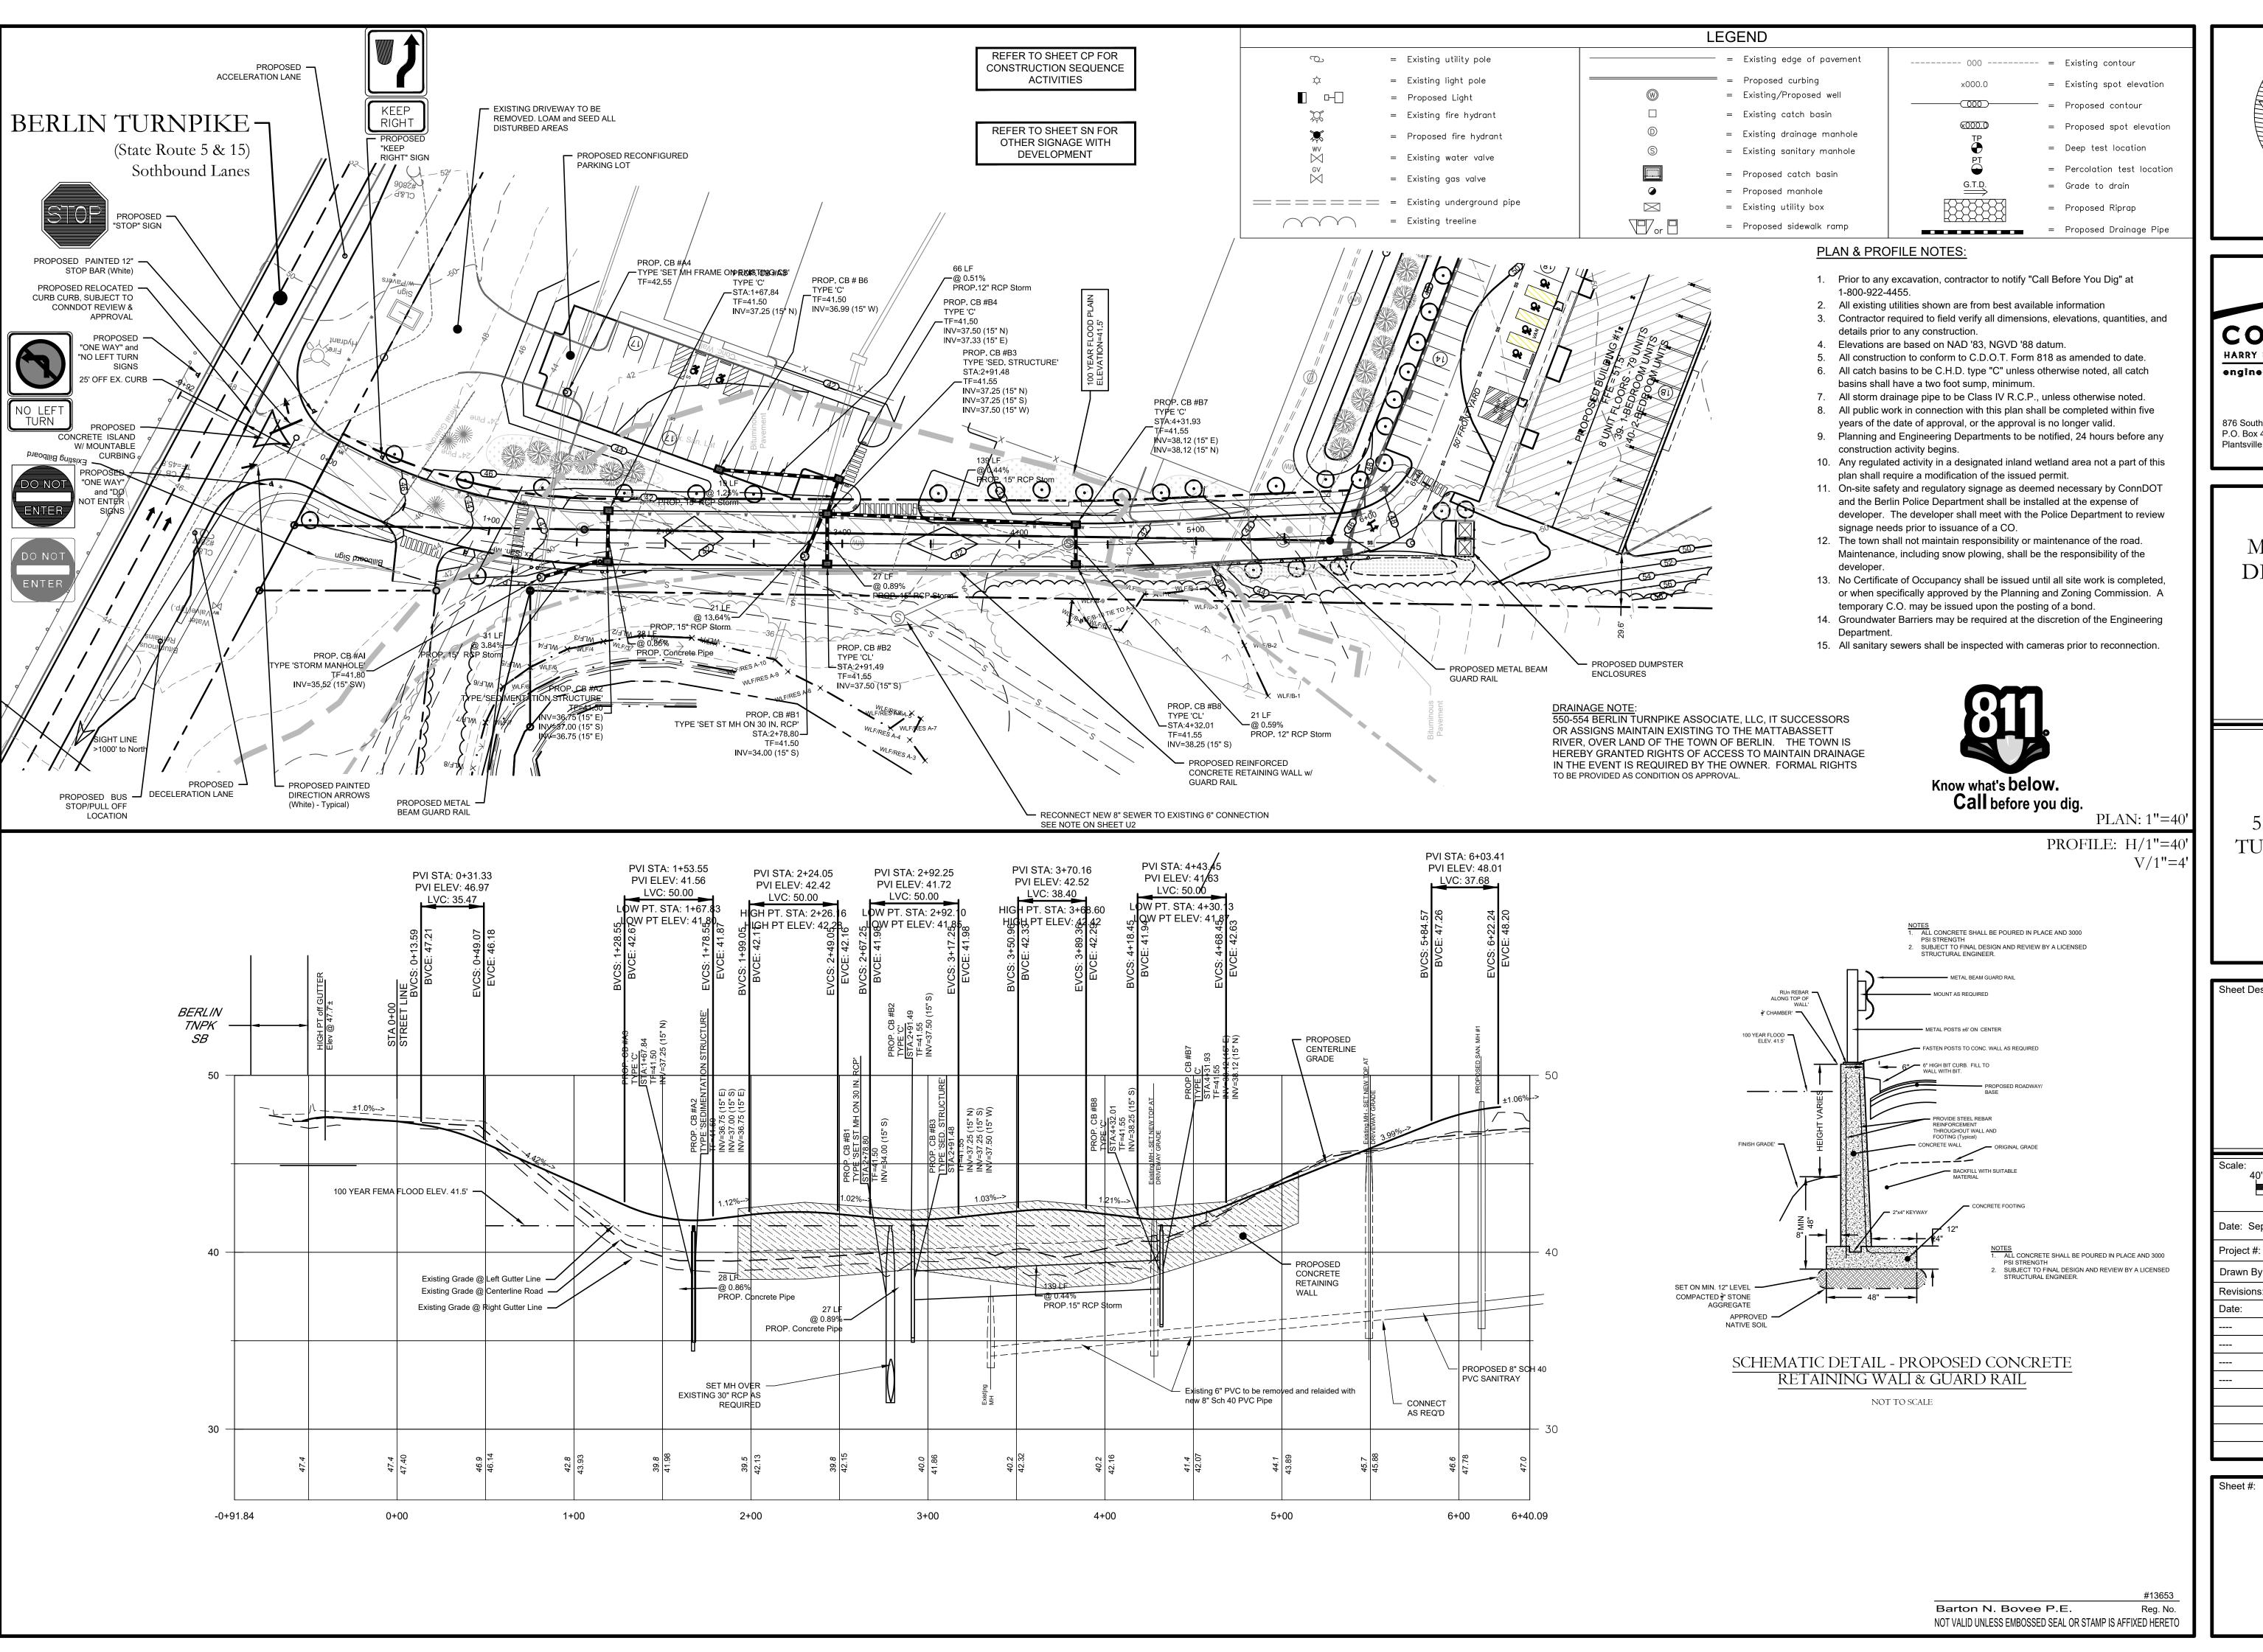
Parcel# 10-2-83-13 522 Berlin Turnpike Berlin, Connecticut

PREPARED FOR:

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SITE GRADING PLAN					
Scale: 40'	20'	0 20' 40'			
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1"=40'					
Date: September 5, 2023					
Project #: 1908		F.B. #:			
Drawn By: BTF	P/BNB	Approved By: BNB			
Revisions:					
Date:	Descrip	otions:			

G2



NORTH

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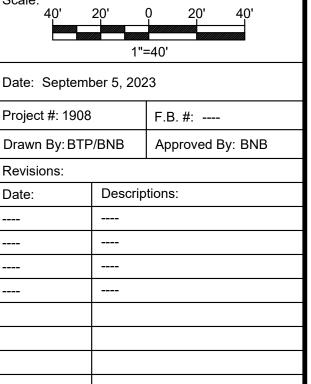
> 522 Berlin Turnpike Berlin, Connecticut

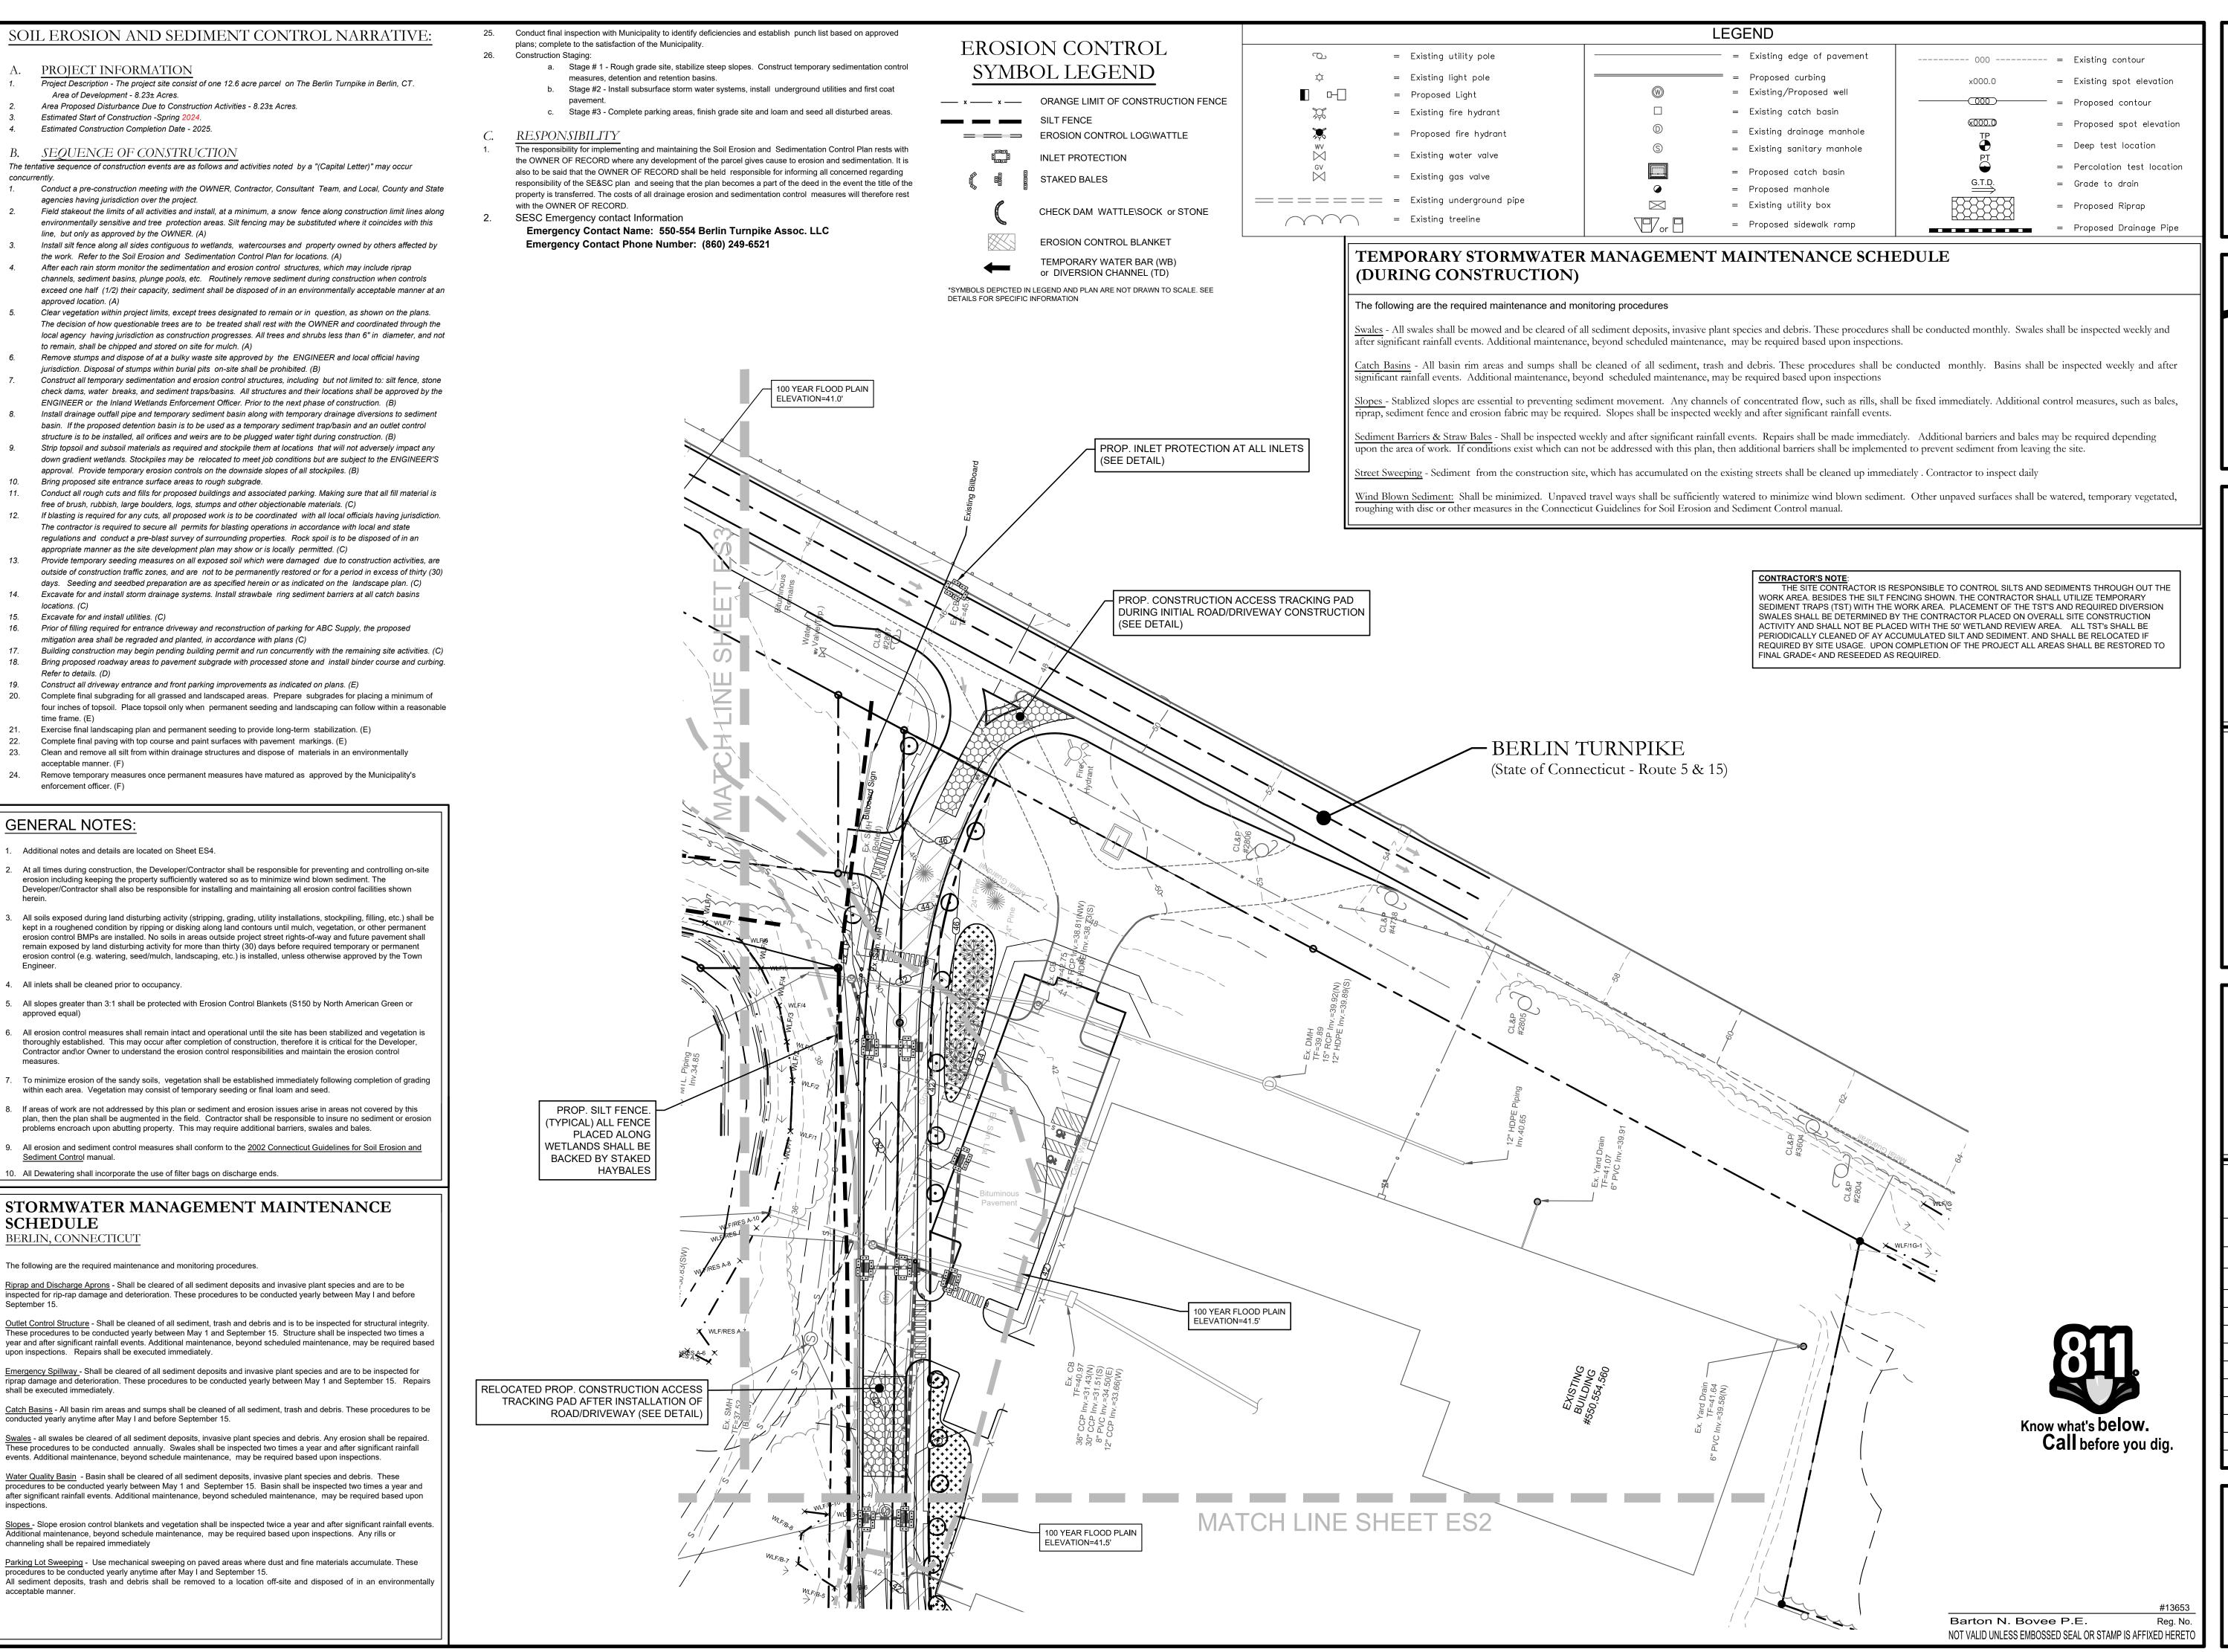
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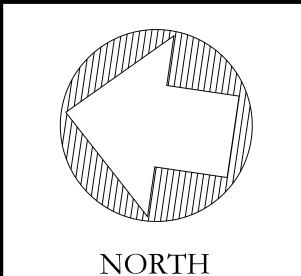
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**Sheet Description:** 

P1 -ENTRANCE ROAD PLAN & **PROFILE** 







COE
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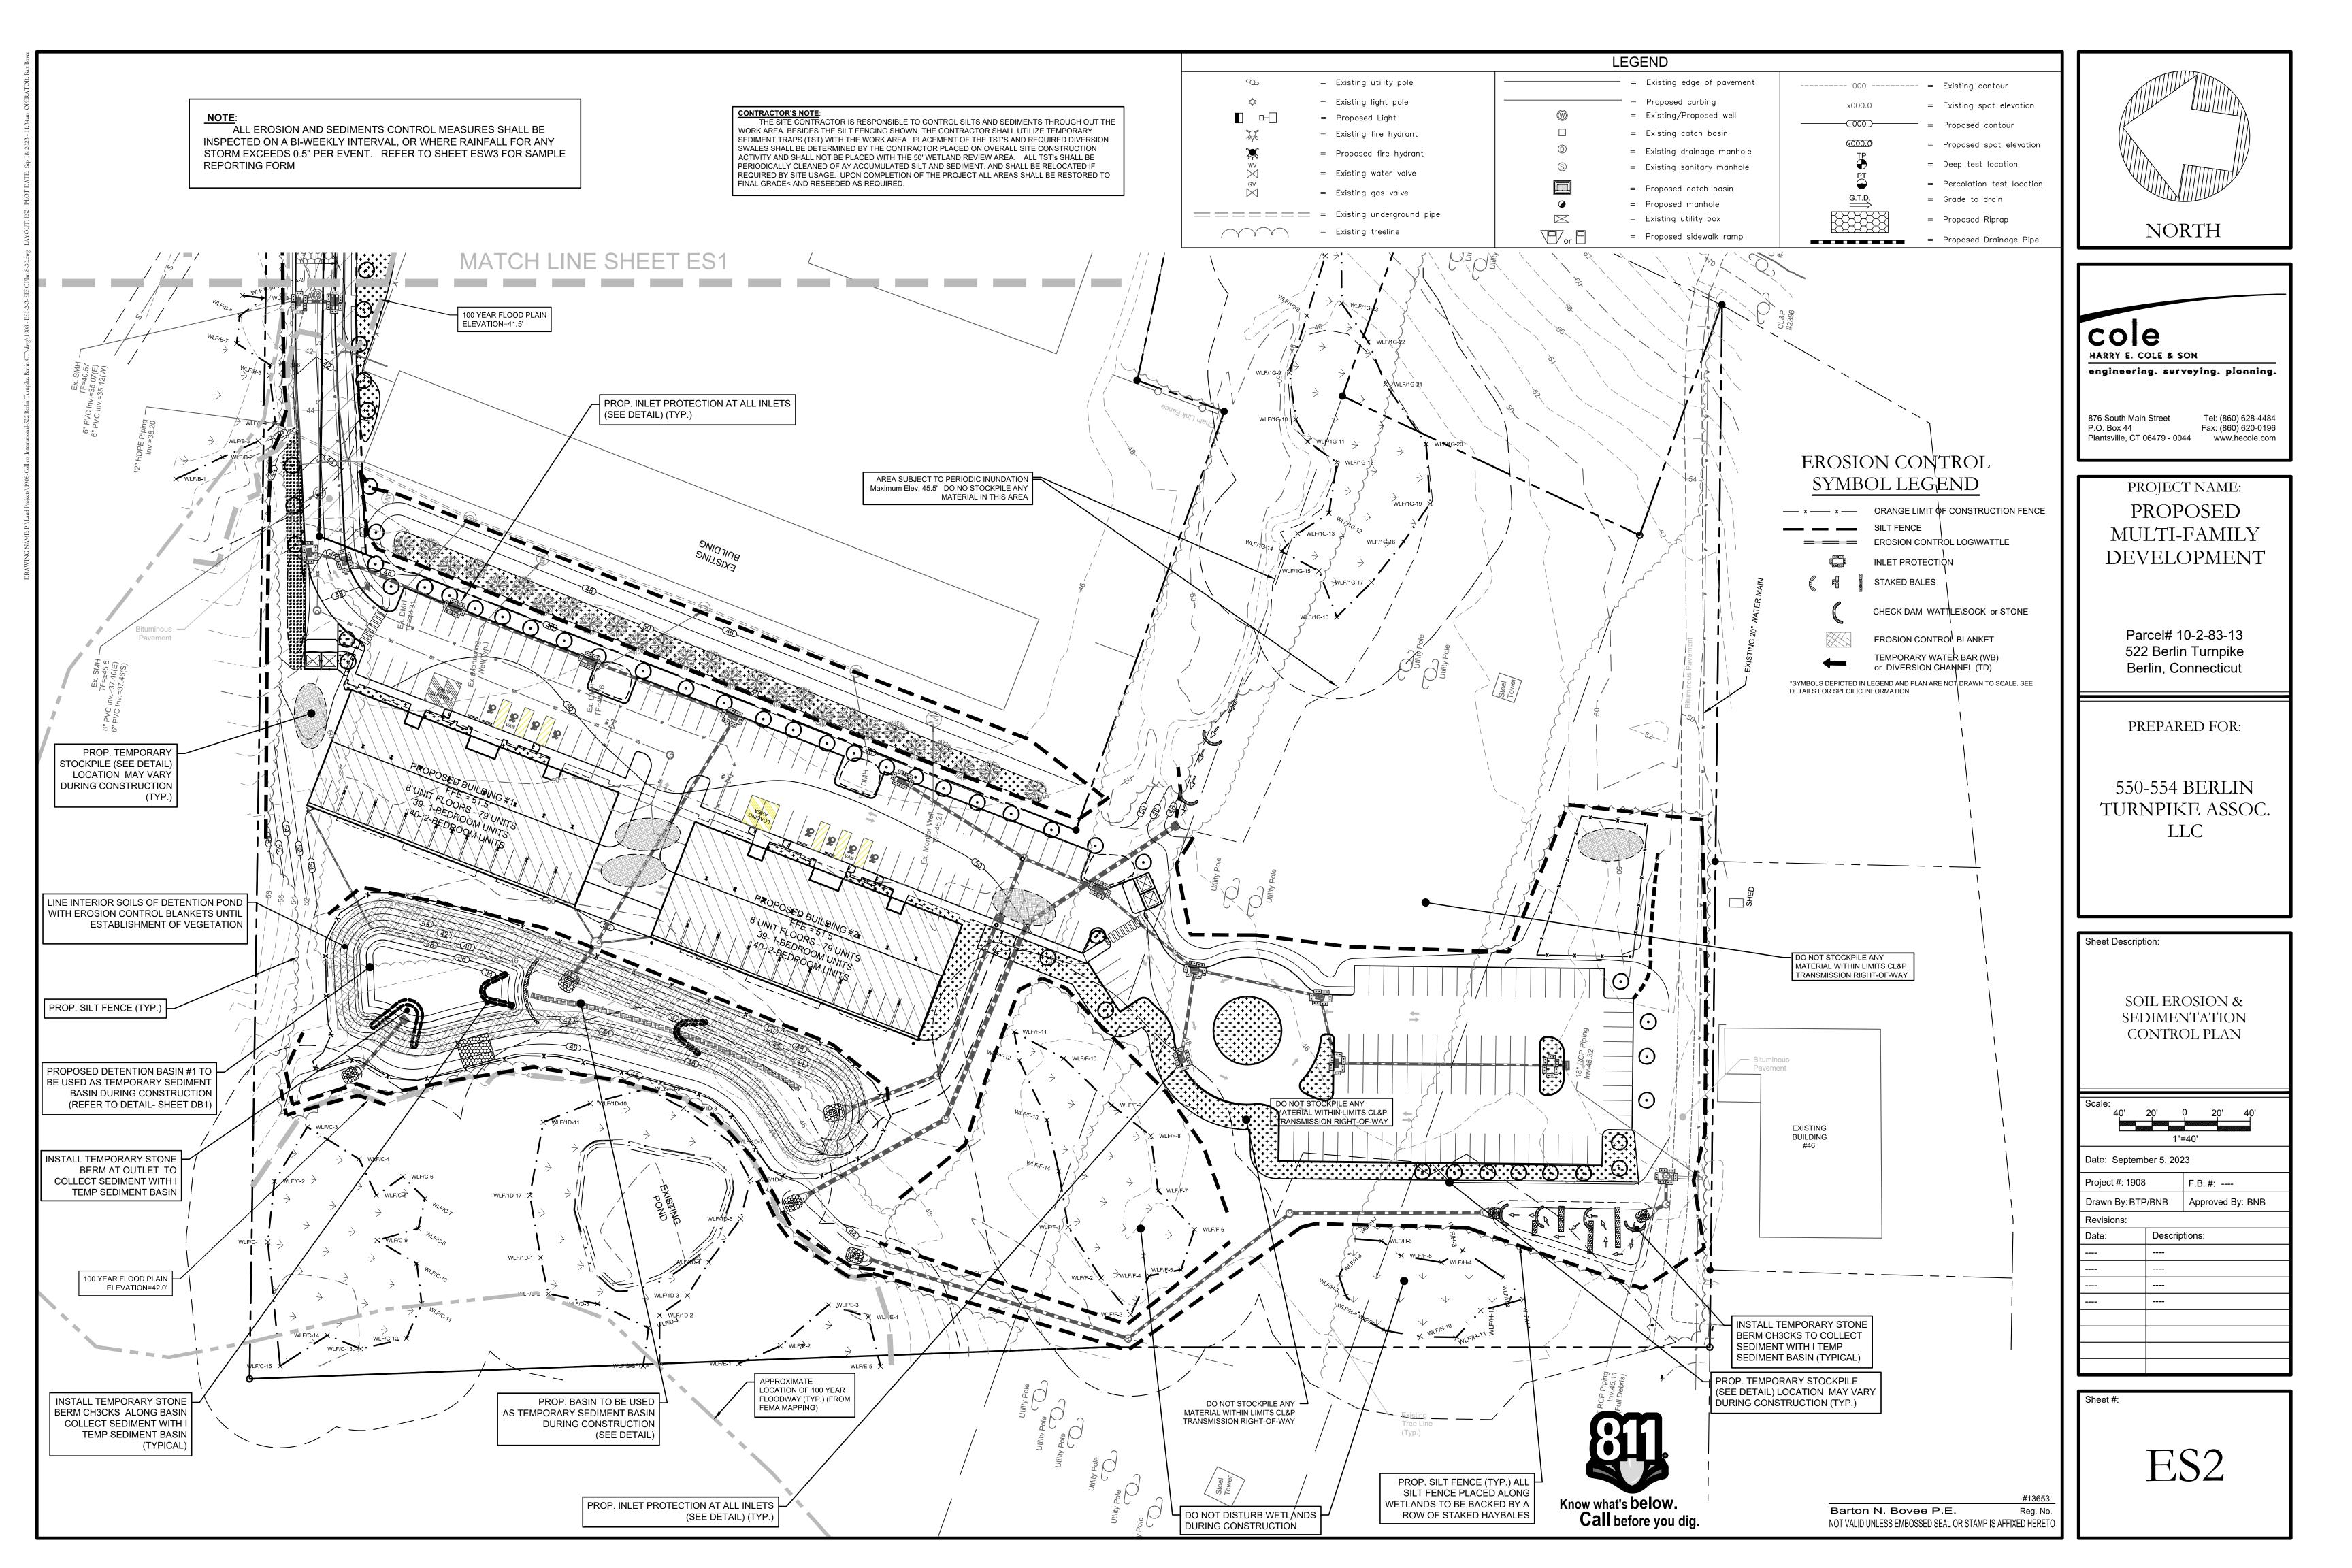
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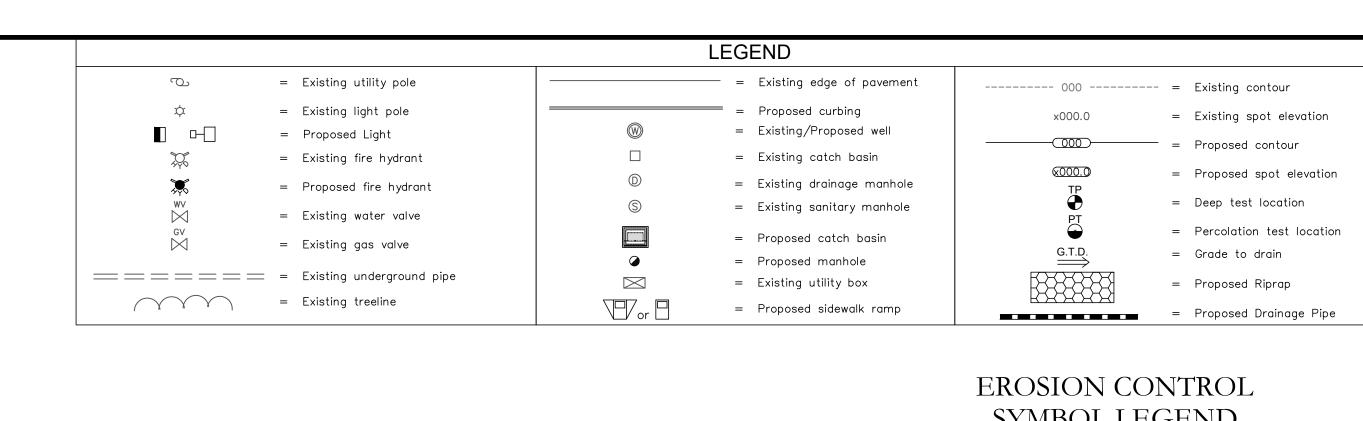
SOIL EROSION & SEDIMENTATION CONTROL PLAN

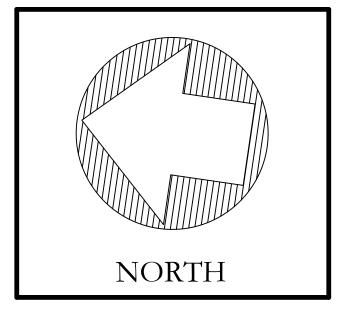
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Project #: 1908		F.B. #:	
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ES1





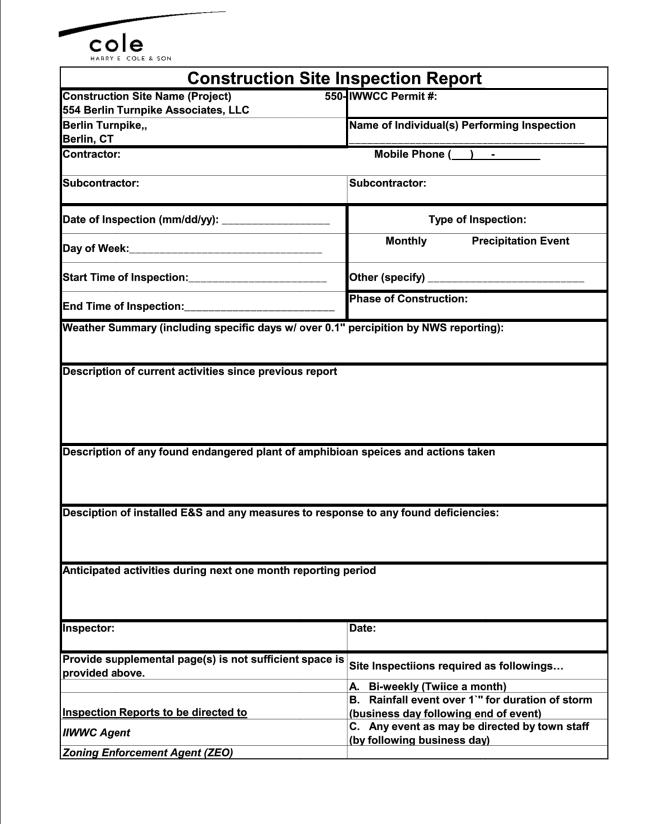


# SYMBOL LEGEND

— x — x — ORANGE LIMIT OF CONSTRUCTION FENCE SILT FENCE EROSION CONTROL LOG\WATTLE INLET PROTECTION STAKED BALES CHECK DAM WATTLE\SOCK or STONE EROSION CONTROL BLANKET

TEMPORARY WATER BAR (WB) or DIVERSION CHANNEL (TD) \*SYMBOLS DEPICTED IN LEGEND AND PLAN ARE NOT DRAWN TO SCALE. SEE DETAILS FOR SPECIFIC INFORMATION

CONSTRUCT TEMPORARY ACCESS ROAD INTO MITIGATION AREA DURING CONSTRUCTION PERIOD. CARE TO BE TAKEN NOT TO CROSS ADJACENT PROPERTY LINE.





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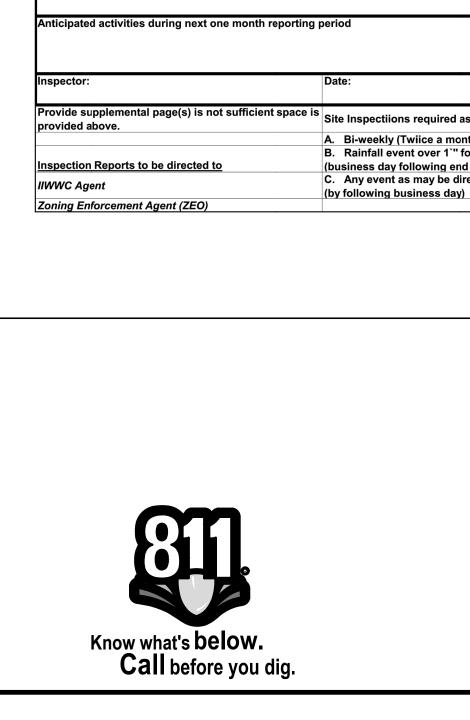
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SOIL EROSION & SEDIMENTATION CONTROL DETAIL

Sheet Description:

Scale:	20'	0 20'	40'			
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Date: Septeml	ber 5, 202	23				
Project #: 1908	}	F.B. #:				
Drawn By: BTF	P/BNB	Approved B	y: BNB			
Revisions:	Revisions:					
Date: Descriptions:						

#13653



PROPOSED SILT FENCE BACKED BY A

ROW OF STAKED HAYBALES ALL

AREA. (Typical).)

PERIMETER OF PROPOSED MITIGATION

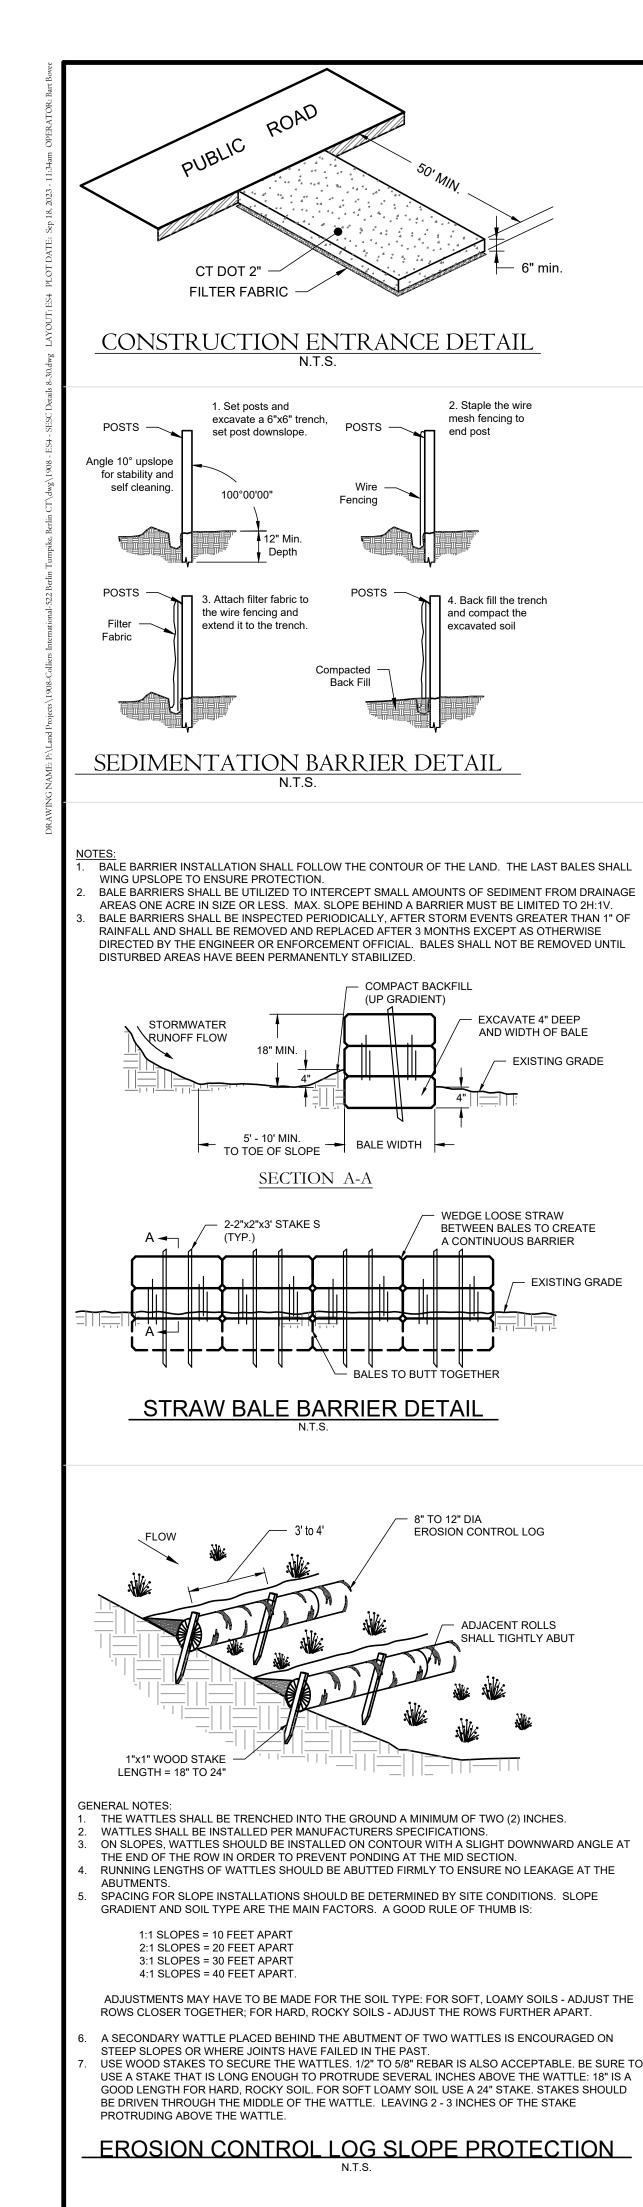
*MATTABASSETT* ~

PROVIDE DEPRESSED SEDIMENT COLLECTION AREA AT LOW EST AREA OF MITIGATION AREA. LINE LOWER PERIMETER WITH SILT FENCE OR HAY BALE CHECK. AREA TO BE CLEANED OR ACCUMULATE SEDIMENT AND REWORKED TO FINALGRADE PRIOR TO FINAL PLANTING OR SEEDING

> PITCH TO DRAIN TO TEMPORARY SEDIMENT COLLECTION AREA DURING CONSTRUCTION (Typical)

APPROXIMATE LOCATION OF 100 YEAR

FLOODWAY (TYP.) (FROM



2. Staple the wire

mesh fencing to

4. Back fill the trench

and compact the

EXCAVATE 4" DEEP AND WIDTH OF BALE

WEDGE LOOSE STRAW

A CONTINUOUS BARRIER

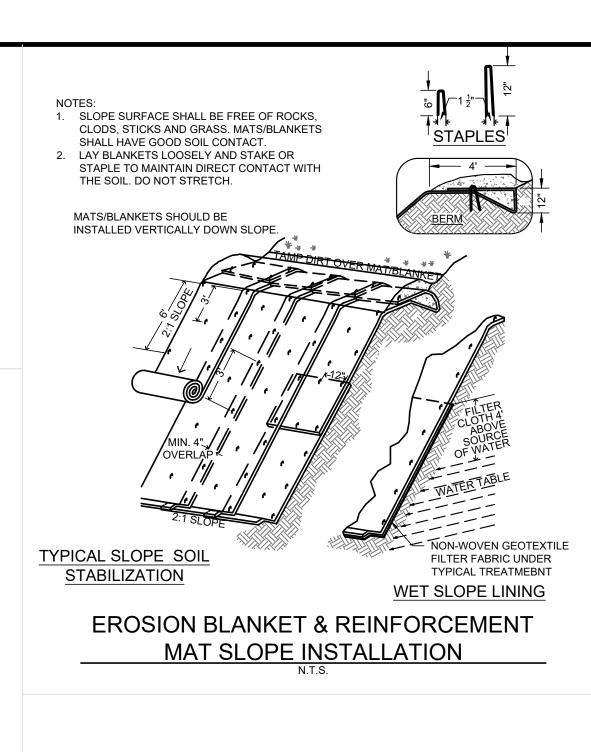
ADJACENT ROLLS

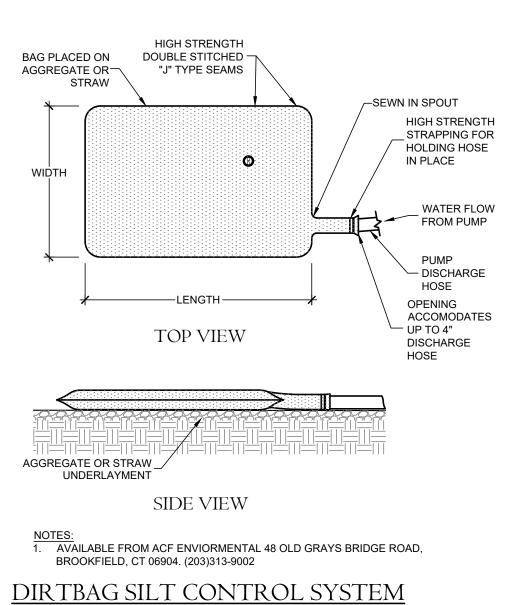
BETWEEN BALES TO CREATE

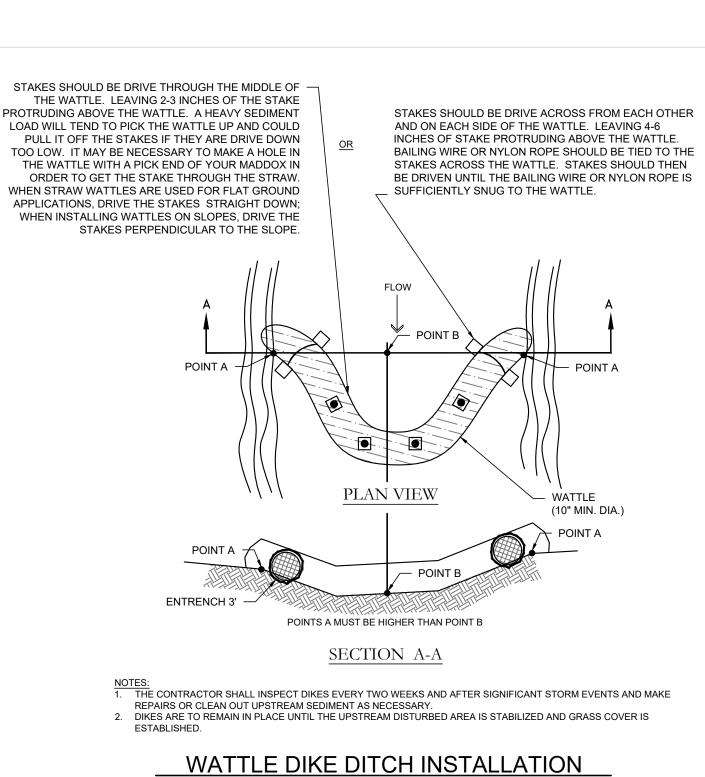
EXISTING GRADE

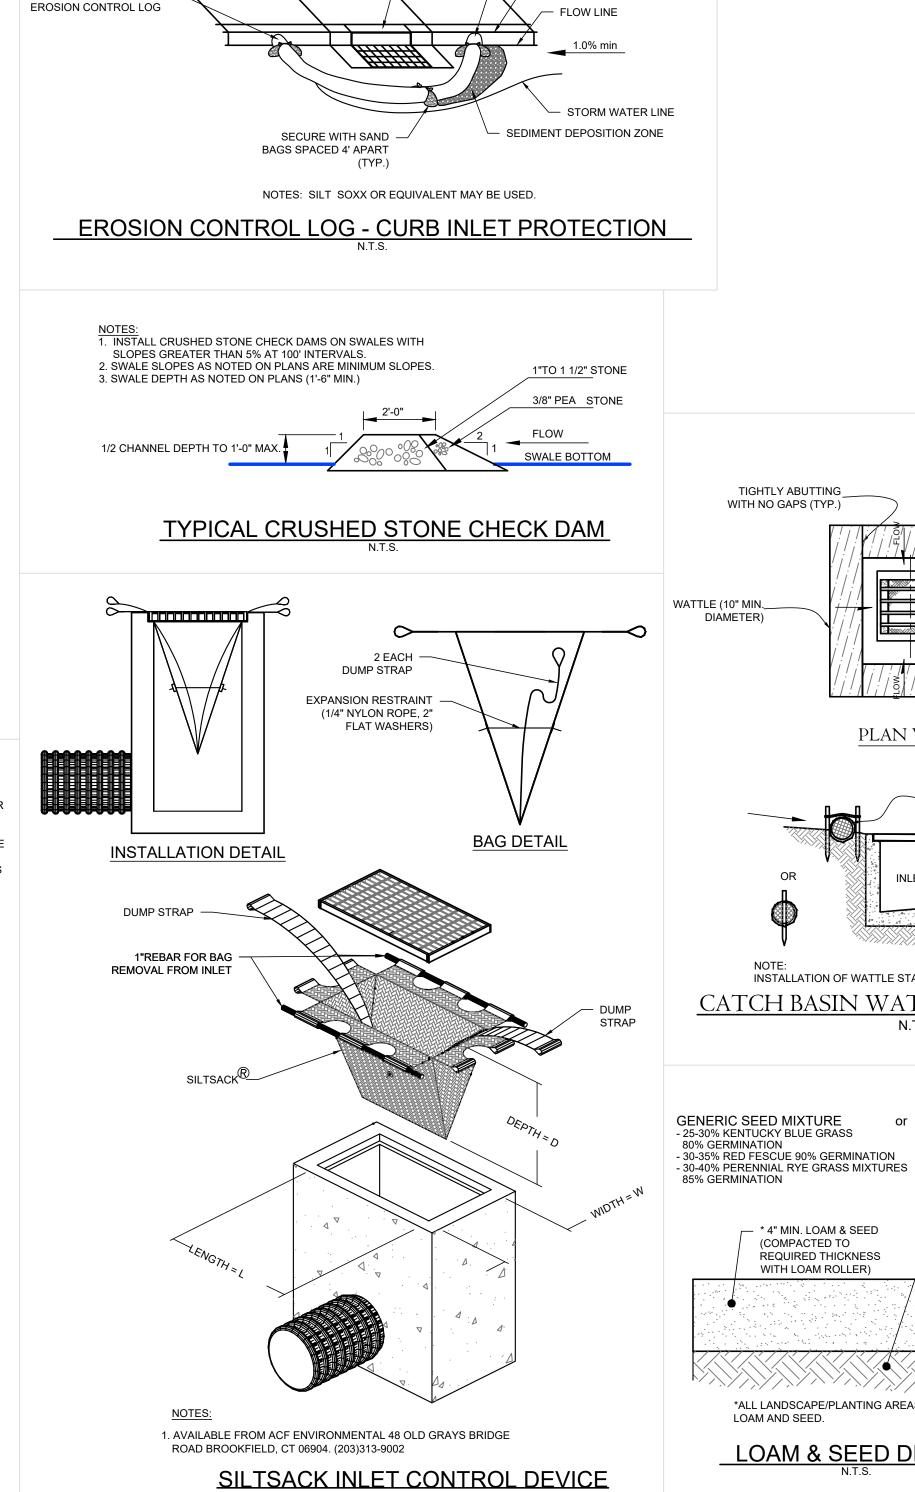
- EXISTING GRADE

excavated soil









AREA CHOSE FOR STOCKPILING SHALL BE DRY AND STABLE

FOR THE TIME OF YEAR, SITE CONDITIONS AND REQUIRED PERIOD OF USE.

IF THE AREA BEHIND THE INLET IS NOT

PREVENT SEDIMENT FROM ENTERING

SIDEWALK -

THE INLET

STABILIZED, A BMP SHOULD BE USED TO

SEE EROSION AND SEDIMENT CONTROL PLAN FOR LOCATIONS.

UPON COMPLETION OF SIOL STOCKPILING, EACH PILE SHALL BE SURROUNDED WITH EITHER SILT FENCING OR

PRESERVATION OF EXISTING TOPSOIL IS BENEFICIAL FOR ALL TYPES OF LAWN OR ORNAMENTAL PLANTINGS.

HAY BALES OR SILT FENCE

TO BE USED WHERE TOPSOIL IS NECESSARY FOR REGRADING AND VEGETATING DISTURBED AREAS. TOPSOIL IS APPLIED

AND PERIPHERAL SEDIMENT TRAPPING BARRIERS. THE STABLIZATION, MEASURE(S) SELECTED SHOULD BE APPROPRIATE

SLOPE OR LESS

EXISTING OR

PROPOSED INLET

MIN. SLOPE

**ENDS SHALL ABUT** 

TOP BACK CURB

TIGHTLY TO BACK OF CURB

TIGHTLY ABUTTING

ENTRENCH WATTLE

3" INTO NATURAL

SESC MANUAL SEED MIXTURE

PER FIGURE PS-2 & PS-3 OF THE

2002 CONNECTICUT GUIDELINES

PERMANENT GRASS SEEDING

SEDIMENT CONTROL MANUAL

FOR SOIL EROSION AND

COMPACTED, GRADED

ACCEPTABLE,

SUBGRADE

GROUND.

INSTALLATION OF WATTLE STAKES MAY VARY

\* 4" MIN. LOAM & SEED

REQUIRED THICKNESS WITH LOAM ROLLER)

\*ALL LANDSCAPE/PLANTING AREAS SHALL RECEIVE

LOAM & SEED DETAIL

(COMPACTED TO

CATCH BASIN WATTLE PROTECTION

N.T.S.

WITH NO GAPS (TYP.)

DIAMETER)

TO SUBSOILS THAT ARE DRAUGHTY (HAVING LOW AVAILIABLE MOISTURE FOR PLANTS), STONEY SALTY, HAVE LOW

PERMEABILITY, OR ARE EXTREMELY ACID. IT IS ALSO USED TO BACKFILL AROUND SHRUB AND TREE TRANSPLANTS.

TEMPORARY STOCKPILING STABILIZATION MEASURES INCLUDE VEGETATIVE COVER, MULCH NONVEGETATIVE COVER,

STARWBALES, THEN STABILIZED WITH VEGITATION OR COVERED WITH POLYETHYLENE SHEETING.

MAXIMUM SLOPE OF STOCKPILE SHALL BE 2:1.

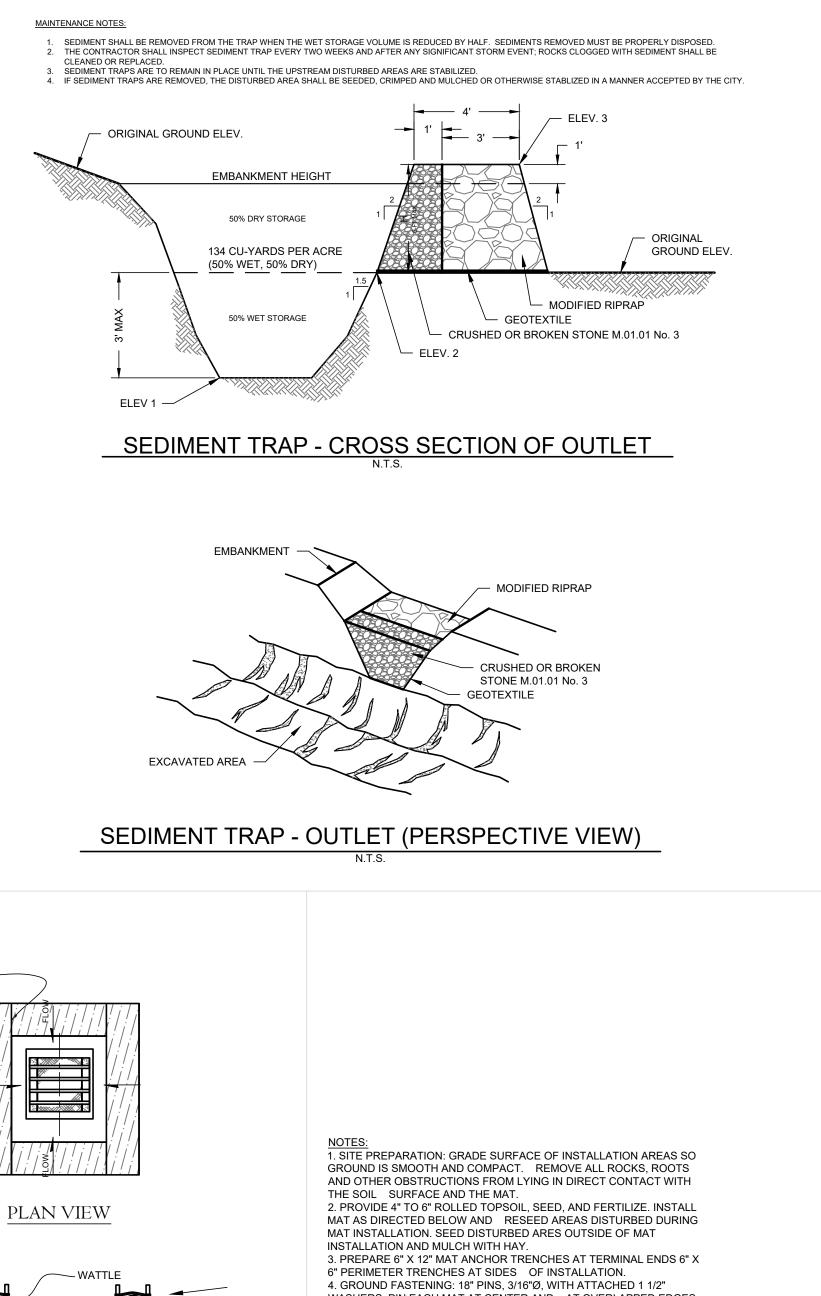
STABILIZE ENTIRE PILE WITH —

VEGETATION OR COVER WITH

/ MIN. SLOPE

INSTALL 6" TO 8" DIA.

POLYETHYLENE SHEETING



ALL WORK SHALL CONFORM TO CONNECTICUT GUIDELINES FOR SOIL EROSION AND SEDIMENT CONTROL.

TRAPS SHOULD NOT BE LOCATED CLOSER THAN 20 FEET FROM A PROPOSED BUILDING FOUNDATION OR EDGE OF ROAD.

A RECTANGULAR AND SHALLOW TRAP, WITH A LENGTH-TO-WIDTH RATIO OF 2:1 OR GREATER IS RECOMMENDED.

USE ONLY FOR TREATMENT OF ONSITE RUNOFF.

NEVER CONSTRUCT A SEDIMENT TRAP ON A FLOWING STREAM OR IN WETLANDS.

3. A GEOTEXTILE SHOULD BE PLACED AT THE STONE-SOIL INTERFACE TO ACT AS A SEPARATOR.

INSTALLATION NOTES:

VOLUME PROVIDE SHALL BE 134 CU-YD/ACRE WITH 50% DRY AND 50% WET STORAGE. (BELOW OUTLET). TYPICAL MAXIMUM DRAINAGE AREA IS 5 ACRES.

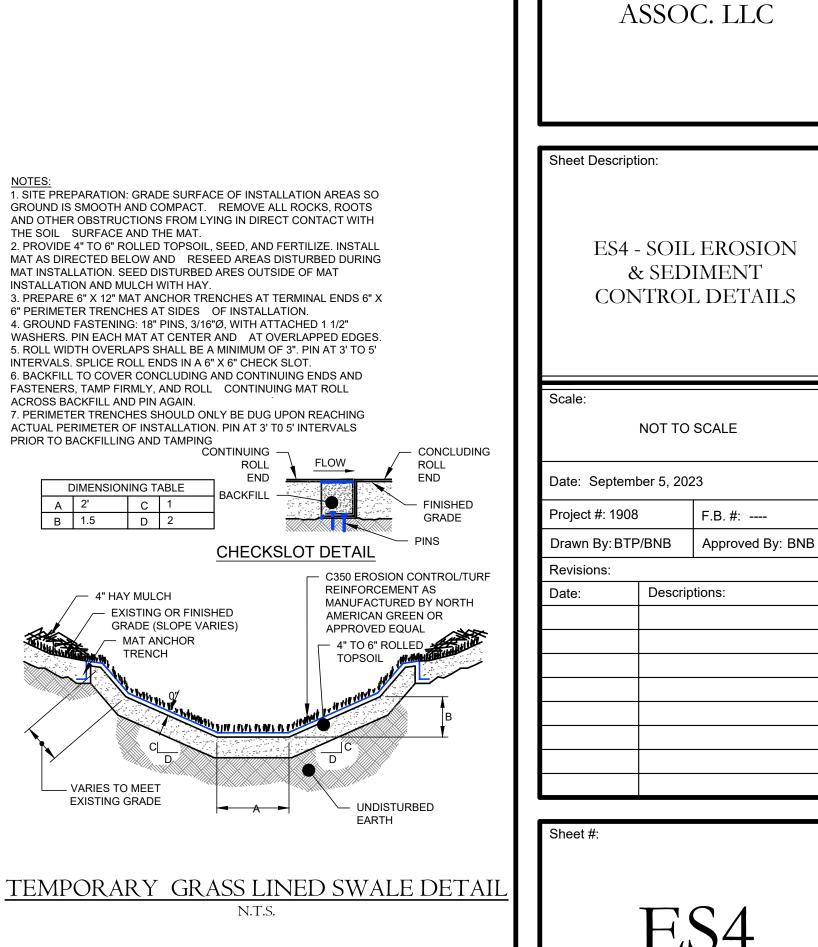
INLETS TO SEDIMENT TRAP SHALL ENTER AT THE FURTHEST DISTANCE TO OUTLET DESIGNED SO AS NOT TO ERODE SIDE SLOPES OF SEDIMENT BASIN

SEDIMENT TRAPS, ALONG WITH OTHER PERIMETER CONTROLS, SHALL BE INSTALLED BEFORE ANY LAND DISTURBANCE TAKES PLACE IN THE DRAINAGE AREA.
THE AREA UNDER THE EMBANKMENT SHALL BE CLEARED AND STRIPPED OF ANY VEGETATION AND ROOTS.

MAXIMUM EMBANKMENT HEIGHT SHALL BE 5 FEFT MEASURED ON THE DOWNSTREAM SIDE. THE MINIMUM TOP EMBANKMENT WIDTH SHALL BE 4 FEFT. SIDE SLOPES FOR

THE EMBANKMENT AND THE EXCAVATED AREAS SHALL BE 2:1 OR FLATTER.

FILL MATERIAL FOR THE EMBANKMENT SHALL BE FREE OF ROOTS OR OTHER VEGETATION, ORGANIC MATERIAL, LARGE STONES, AND OTHER OBJECTIONABLE MATERIAL.



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876 South Main Street

P.O. Box 44

HARRY E. COLE & SON

engineering, surveying, planning,

Plantsville, CT 06479 - 0044 www.hecole.com

PROPOSED

**MULTI-FAMILY** 

DEVELOPMENT

Parcel# 10-2-83-13

522 Berlin Turnpike

Berlin, Connecticut

OWNER & PREPARED FOR

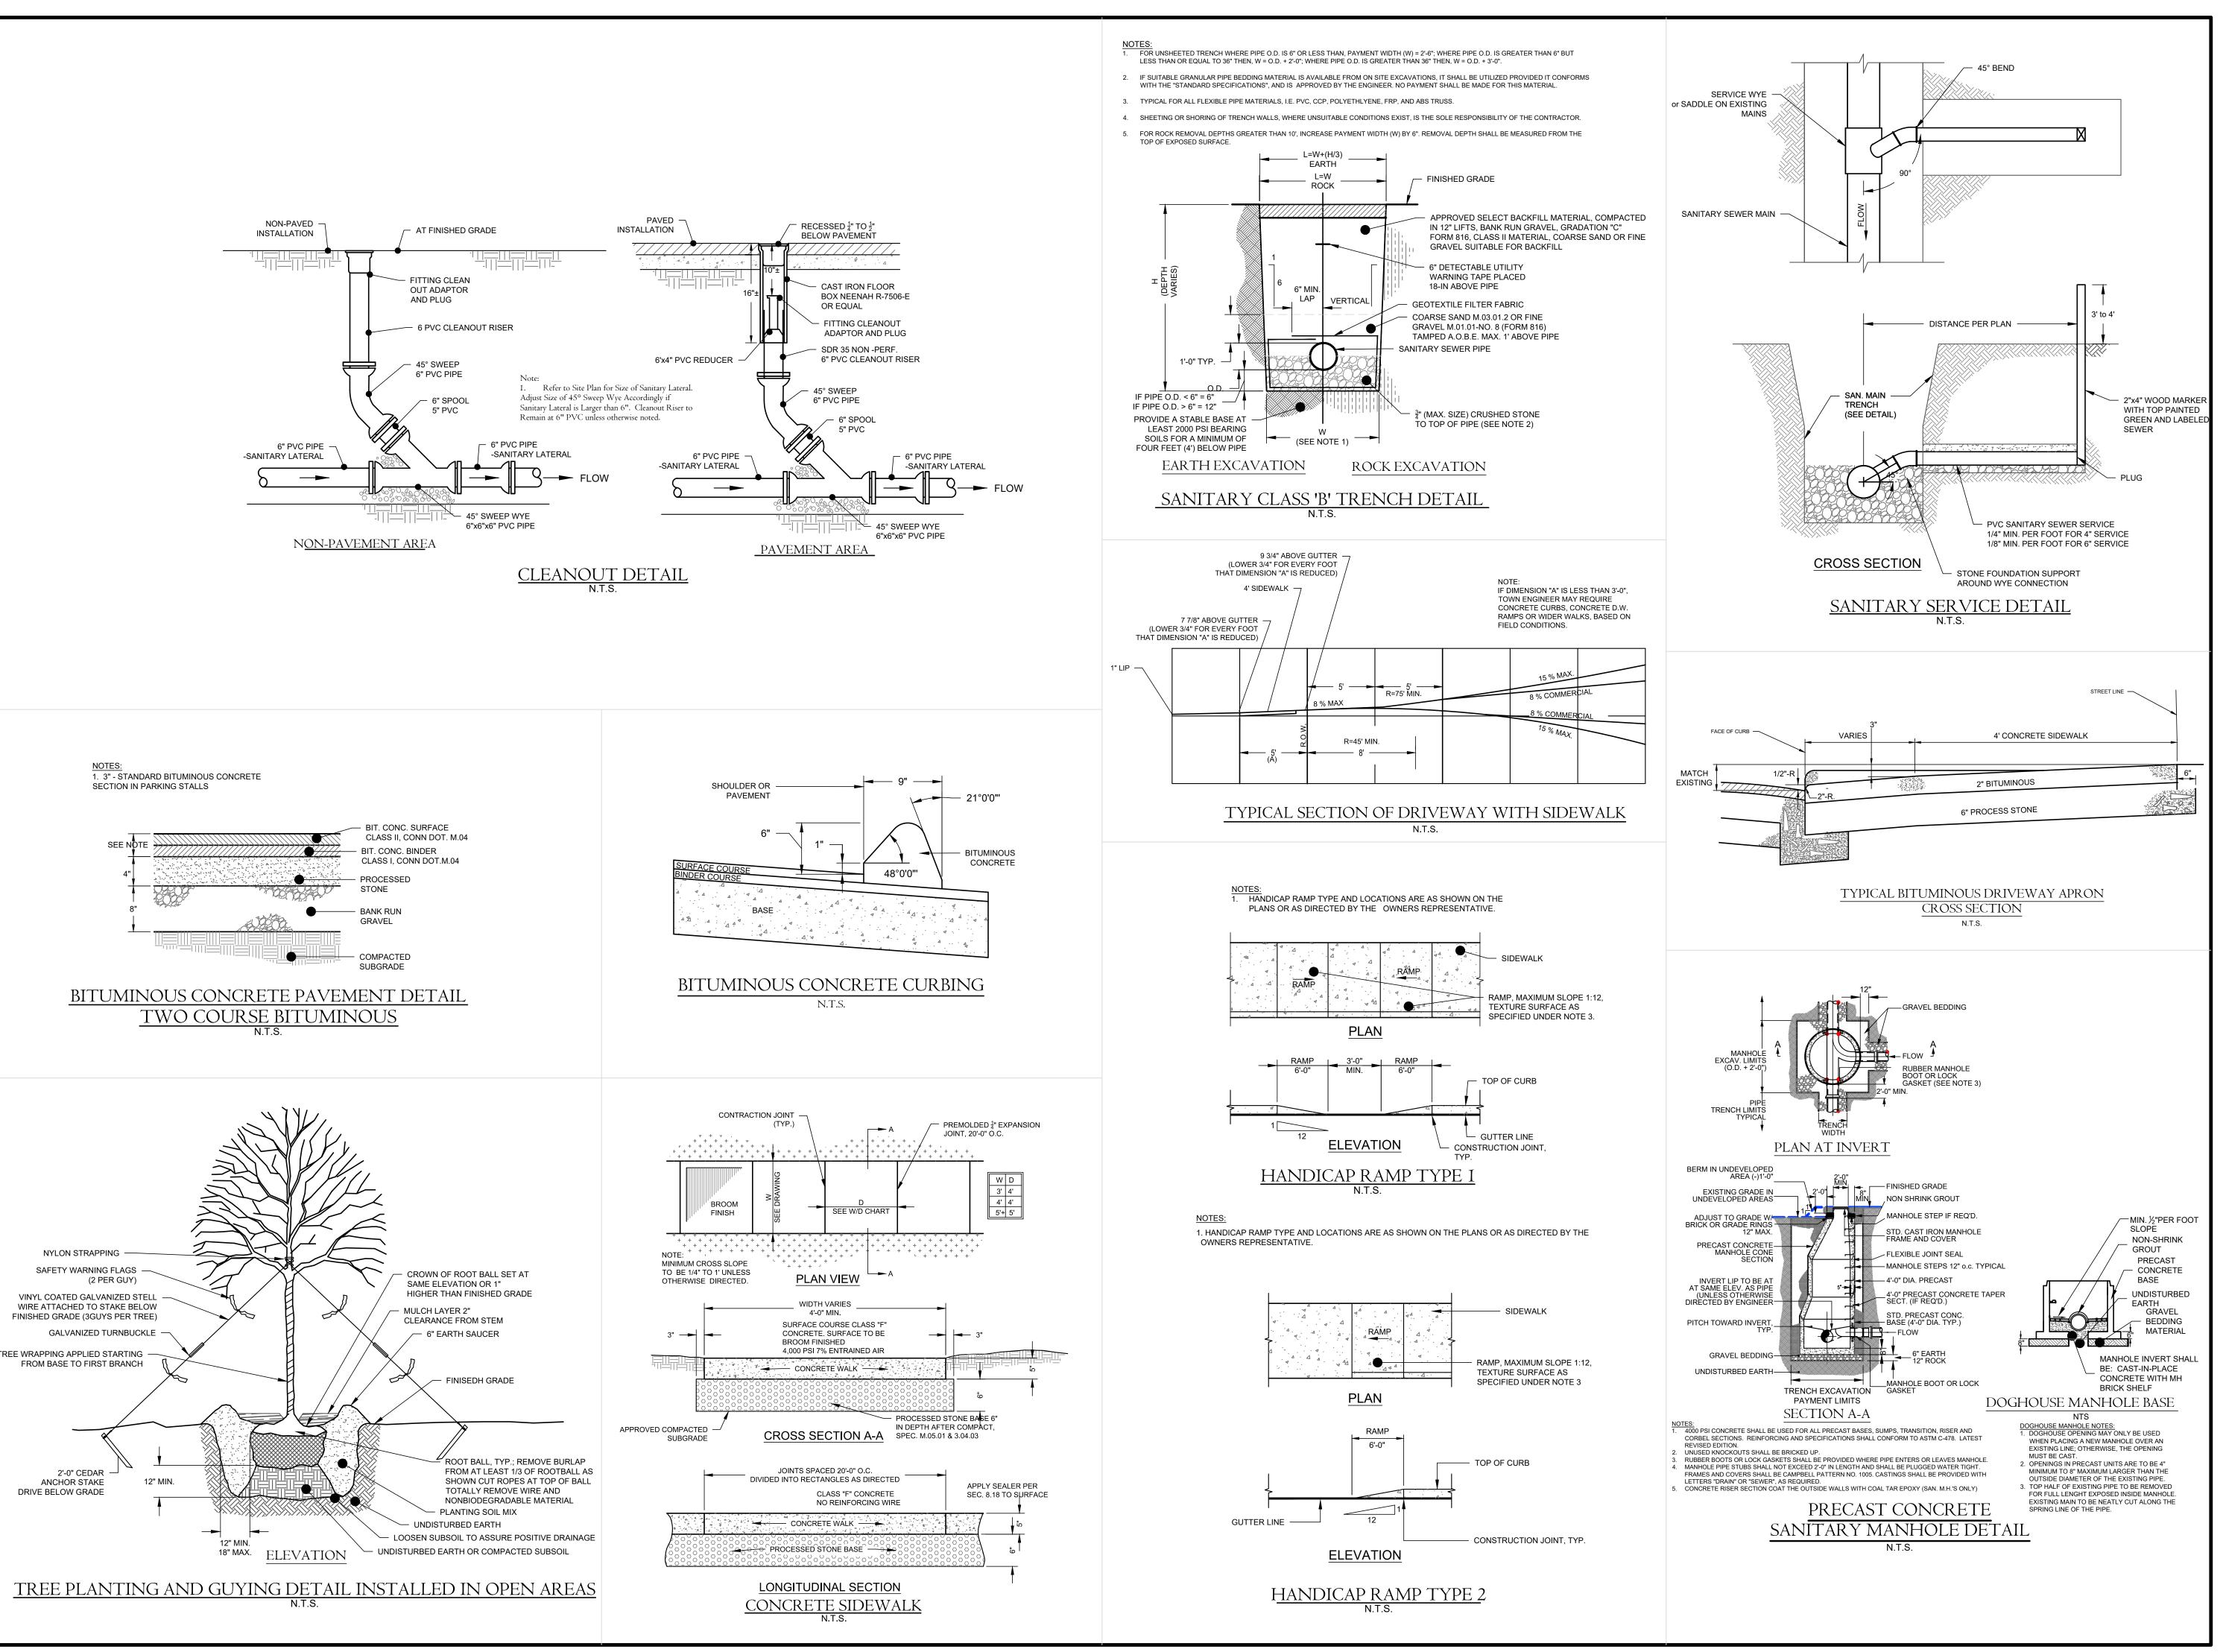
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**TURNPIKE** 

Tel: (860) 628-4484

Fax: (860) 620-0196



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**Sheet Description:** 

DETAILS

Scale:

N.T.S.

Date: September 5, 2023

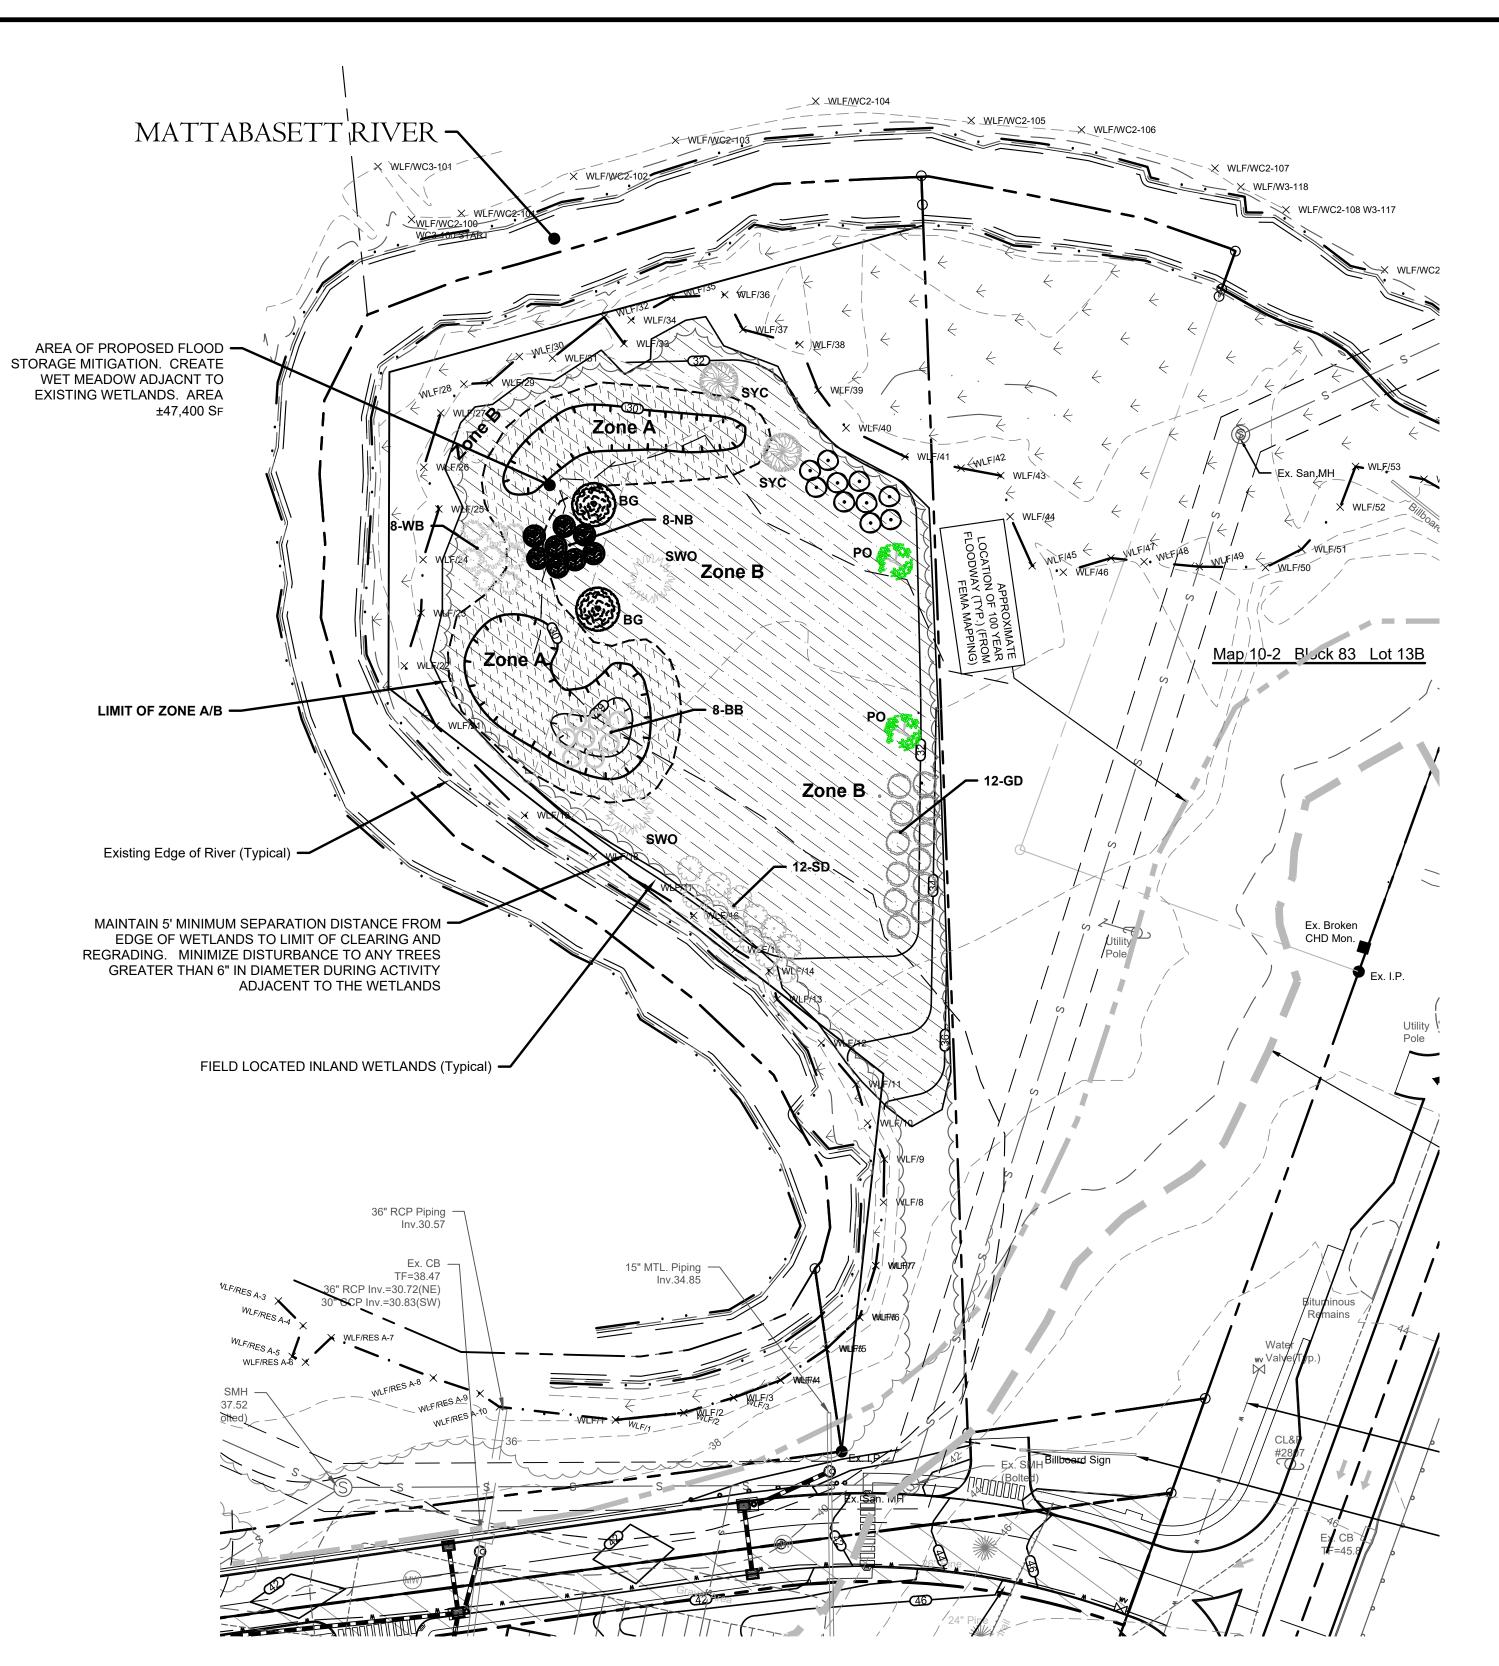
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Drawn By: BTP/BNB Approved By: MSL

Revisions:

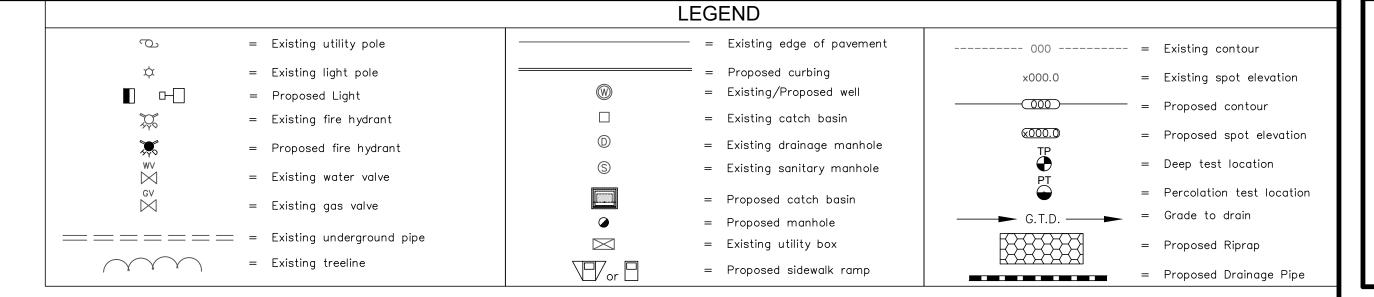
Date: Descriptions:
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Sheet #:

D1



PROPOSED MITIGATION AREA



# PLAN FOR CREATING A WET MEADOW HABITAT WITHIN A PROPOSED FLOOD STORAGE MITIGATION AREA

### **IMPLEMENTATION & MAINTENANCE NOTES**

### 1.0 <u>introductior</u>

<u>A WET MEADOW</u> 'MOSAIC' WETLAND HABITAT WILL BE CREATED AND MAINTAINED AT THE PROPOSED MULTI-FAMILY RESIDENTIAL DEVELOPMENT. SOILS AT THE SUBJECT WET MEADOW SHALL BE PREDOMINATELY POORLY DRAINED TO SOMEWHAT POORLY DRAINED AND PREDOMINATELY SEASONALLY SATURATED. THE 'SUMPS' WILL BE SEASONALLY FLOODED.

THE PLAN INCLUDES: (1) CREATION OF WET MEADOW 'MOSAIC' HABITAT THROUGH SEEDING AND PLANTING OF SHRUBS AND TREES, AND (2) ANNUAL MAINTENANCE OF THE WET MEADOW HABITAT. THE GOAL OF THE ANNUAL MAINTENANCE IS TO PROVIDE A PRODUCTIVE VEGETATIVE COVER TYPE THAT WILL ATTRACT CERTAIN WILDLIFE AND INVERTEBRATES INCLUDING POLLINATOR SPECIES. CURRENTLY THIS AREA IS CHARACTERIZED PREDOMINATELY BY YOUNG RUDERAL FOREST REPLETE WITH INVASIVE SPECIES, INCUDING MULTIFLORA ROSE, MORROW'S HONEYSUCKLE, GARLIC MUSTARD AND ASIATIC BITTERSWEET.

**NOTE:** THE INITIAL WETLAND CREATION WORK, SHALL BE SUPERVISED BY AN ECOLOGIST (OR WETLAND SCIENTIST), INCLUDING INITIAL PLANTING AND SEEDING. A PRE-IMPLEMENTATION MEETING SHALL TAKE PLACE AT LEAST ONE MONTH PRIOR TO PLAN IMPLEMENTATION, BETWEEN THE WETLAND SCIENTIST, THE SITE CONTRACTOR, THE LANDSCAPER, AND THE TOWN'S WETLAND AGENT, AT THE TOWN'S DISCRETION.

### 2.0 <u>wetland creation</u>

### OPSOIL

1. <u>A MINIMUM</u> 4 INCHES OF LOAMY TOPSOIL SHALL BE USED WITHIN ZONE B THE MITIGATION AREA, WHILE A <u>MINIMUM</u> OF 6 INCHES OF LOAMY TOPSOIL SHALL BE USED IN ZONE A.

2. A 1-INCH <u>TOPDRESSING</u> CONSISTING OF 2-YEAR OLD COMPOST SHALL BE APPLIED TO BOTH ZONE A AND ZONE B.

### <u>PLANTINGS</u>

- 1. <u>ORDER</u> THE <u>WOODY PLANTING MATERIALS</u> AND <u>SEED MIXES</u> (SEE TABLES 1 AND 2) FOR DELIVERY AT LEAST A MONTH PRIOR TO PLAN IMPLEMENTATION. STORE IN SHADE WHEN THEY ARRRIVE AND INSTALL WITHIN THREE DAYS OF DELIVERY.
- 2. <u>A WETLAND PROFESSIONAL OR ECOLOGIST</u> SHALL SPECIFY PLANTING AND SEEDING LOCATIONS FOLLOWING THE PLAN.

  3. <u>SEEDING</u>: FOR BARE OR SPARCELY VEGETATED AREAS, AFTER MIXING 1:1 WITH CLAY, OR NON-CLUMPING KITTY LITTER, SPREAD
- 4. FOR SPRING SEEDING IN MOIST, BUT NOT SATURATED SOIL, LIGHTLY RAKE IN SEED (LESS THAN ½ INCH DEEP), TAMP DOWN, AND LIGHTLY MULCH WITH STRAW (FREE OF SEEDS) TO HOLD MOISTURE FOR GERMINATION. FOR FALL SEEDING, WAIT UNTIL AFTER HARD FROST; SEED MAY SIMPLY BE SOWN. SNOW AND FROST WILL INCORPORATE INTO THE SOIL. NOTE THAT COLD STRATIFICATION WILL INCREASE GERMINATION RATES OF SOME SPECIES IN A FALL SEEDING, BUT MORE SEEDS WILL ALSO BE EATEN BY WILDLIFE OR WASHED AWAY. IF SOIL IS SATURATED, BROADCAST SOIL ON SURFACE WITHOUT RAKING.
- 5. SPREAD A THIN LAYER OF STRAW MULCH OVER ALL SEEDED AREAS WITHOUT STANDING WATER, ALLOWING SOME LIGHT

# 3.0 INITIAL FOLLOW-UP AND MAINTENANCE

1. <u>THE WETLAND ECOLOGIST OR WETLAND SCIENTIST</u> SHALL INSPECT THE SITE WITHIN 6 WEEKS AFTER PLAN IMPLEMENTATION TO MONITOR SURVIVAL OF SHRUBS AND GERMINATION OF SEEDED AREAS.

# 4.0 INVASIVE PLANT CONTROL

1. THE ECOLOGIST OR WETLAND SCIENTIST WILL FLAG WOODY INVASIVES TO BE REMOVED WITHIN THE WET MEADOW HABITAT AND ITS IMMEDIATE PERIMETER DURING **TWO (2) YEARS** <u>FOLLOWING</u> THE YEAR OF PLAN IMPEMENTATION (I.E., <u>YEAR 2</u> THROUGH YEAR 3) FOLLOWING THE PROCEDURES PROMULGATED BY THE CT DEEP AND THE NATURE CONSERVANCY.

# 5.0 MONITORING

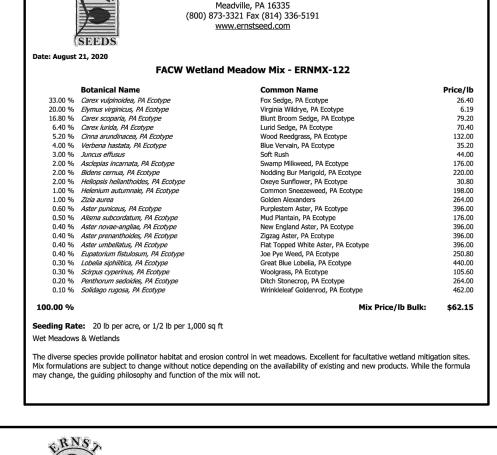
- . <u>INSPECTIONS</u> BY A QUALIFIED WETLAND PROFESSIONAL OR ECOLOGIST SHALL TAKE PLACE DURING THE GROWING SEASON, ONCE FOLLOWING INSTALLATION, AND ONCE DURING EACH OF THE **TWO (2) NEXT GROWING SEASONS**, IN LATE MAY THROUGH JUNE. ADDITIONAL INSPECTIONS MAY BE NECESSARY AT THE DISCRETION OF THE WETLAND SCIENTIST TO ENSURE THE SUCCESS OF THE WETLAND HABITAT CREATION.
- 2. DURING INSPECTIONS, CHECK MITIGATION AREA FOR SEEDLINGS OF *INVASIVE SPECIES* AND MECHANICALLY REMOVE. THESE SPECIES INCLUDE, BUT ARE NOT LIMITED TO, COMMON REED, MORROW'S HONEYSUCKLE, MULTIFLORA ROSE, ASIATIC BITTERSWEET, JAPANESE BARBERRY, GLOSSY BUCKTHORN, AND GARLIC MUSTARD. INSPECTIONS SHALL BE DONE BY THE WETLANDS PROFESSIONAL, WHO COULD ALSO IDENTIFY OTHER INVASIVE PLANT SPECIES, BUT PERSONNEL TRAINED BY THE PROFESSIONAL IN IDENTIFICATION OF INVASIVE SEEDLINGS MAY ASSIST WITH MECHANICAL REMOVAL (WEEDING).
- 3. A BRIEF <u>REPORT</u> TO THE TOWN'S INLAND WETLANDS AND WATERCOURSES AGENCY WILL SUBMITTED BY NOVEMBER 30 IH OF THE MONITORING YEAR.

# 6.0 MAINTENANCE

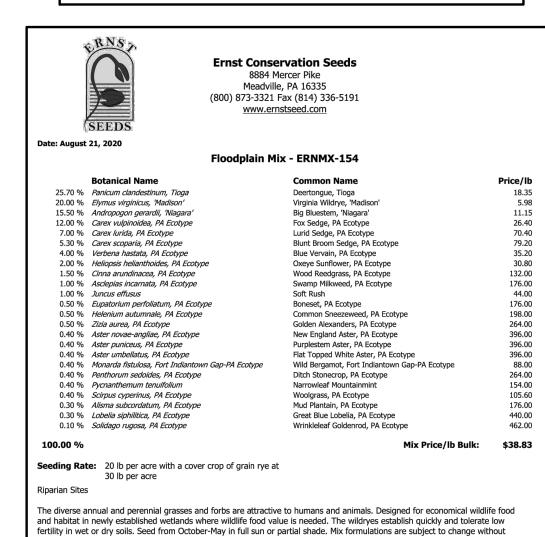
- 1. <u>MOWING</u> SHALL TAKE PLACE ON ANNUAL BASIS AT THE WET MEADOW. MOWING HEIGHT WILL NO LESS THAN 4 TO 6 INCHES FROM THE SOIL SURFACE. <u>CARE SHALL BE TAKEN TO AVOID SHRUB CLUSTERS</u>.
- 2. <u>MOWING</u> WILL TAKE PLACE THE LAST WEEK OF JUNE OF A GIVEN YEAR, OR ALTERNATIVELY THE FIRST WEEK OF NOVEMBER OR THE LAST WEEK OF OCTOBER IF SNOW IS IN THE FORECAST.

Table 1. Trees & Shrubs						
Scientific Name	Common Name	<u>Planting</u>	<u>Size</u>	<u>Form</u>	<u>Totals</u>	
		<u>Code</u>				
TREES						
Nyssa sylvatica	Black gum	BG	4'-6'	nursery pot	2	
Quercus palustris	Pin ok	PO	4'-6'	nursery pot	2	
Platanus occidentalis	Sycamore	SYC	4'-6'	nursery pot	2	
Quercus bicolor	Swamp white oak	SWO	4'-6'	nursery pot	2	
TALL TO MEDIUM SHR	UBS					
Swida racemosa	Gray dogwood	GD	3'-4'	nursery pot	12	
Swida amomum	Silky dogwood	SD	3'-4'	nursery pot	12	
llex verticillata	Winterberry	WB	3'-4'	nursery pot	8	
Clethra alnifolia	Sweet pepperbush	SPB	3'-4'	nursery pot	10	
Cephalanthus occidentalis	Buttonbush	BB	3'-4'	nursery pot	8	
Vibumum lentago	Nannyberry	NB	3'-4'	nursery pot	8	
Total:					66	

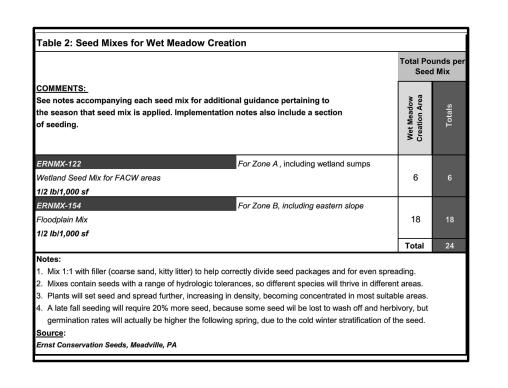
MITIGATION PLAN AND NOTES PROVIDED BY Rema Ecological Services, LLC

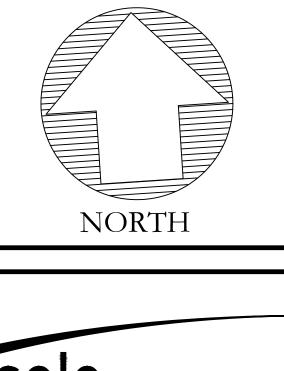


**Ernst Conservation Seeds** 



notice depending on the availability of existing and new products. While the formula may change, the guiding philosophy and





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MULTI-FAMILY
DEVELOPMENT

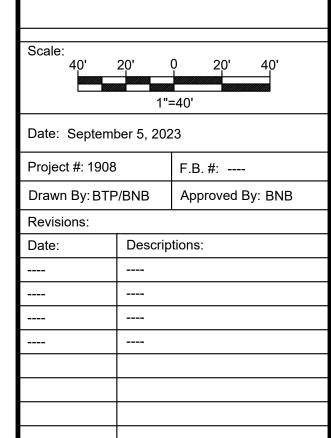
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Sheet Description:

MITIGATION PLAN and NOTES



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